ELECTRIC: PADUCAH POWER 1500 BROADWAY STREET PADUCAH, KY 42001 CONTACT: KERRY FULCHER PHONE: 270-210-4579

ATMOS ENERGY 3510 COLEMAN ROAD PADUCAH, KY 42001 CONTACT: TANNER WILKERSON PHONE: 270-438-2873

1800 NORTH 8TH STREET

PADUCAH, KY 42001

CONTACT: SCOTT SMITH

PHONE: 270-444-5561

SANITARY SEWER
PADUCAH McCRACKEN JSA

CONTACT: JOSH WEBB, P.E.

621 NORTHVIEW STREET

PADUCAH, KY 42001

<u>Water:</u> Paducah water

TELEPHONE: 810 KENTUCKY AVENUE PADUCAH, KY 42001 CONTACT: ALAN SHELBY PHONE: 270-444-5048

<u>CABLE:</u> COMCAST 800 BROADWAY STREET PADUCAH, KY 42001 CONTACT: STEVE PARMLEY

PHONE: 270-442-6382 STORM WATER: CITY OF PADUCAH CITY HALL -

PHONE 270-575-0056 <u>PLANNING/ZONING:</u> CITY OF PADUCAH CITY HALL — PLANNING DEPARTMENT PADUCAH, KY 42001 SENIOR PLANNER


BURIED UTILITIES NOTE


BURIED UTILITIES ARE SHOWN AT THEIR APPROXIMATE LOCATION BASED UPON INFORMATION OBTAINED FROM LOCAL UTILITY COMPANIES AND FIELD EVIDENCE. OTHER BURIED UTILITIES MIGHT EXIST ON THE SUBJECT SITE THAT ARE NOT SHOWN ON THIS DRAWING.

Know what's **below**. Call before you dig. Call 811 or 800-752-6007

www.kentucky811.org Two Business Days Before You Dig IT'S THE LAW

BASIS OF BEARINGS: ALL BEARINGS SHOWN ON THIS DRAWING ARE BASED UPON KENTUCKY SOUTH ZONE-1602,

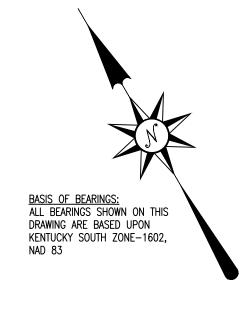

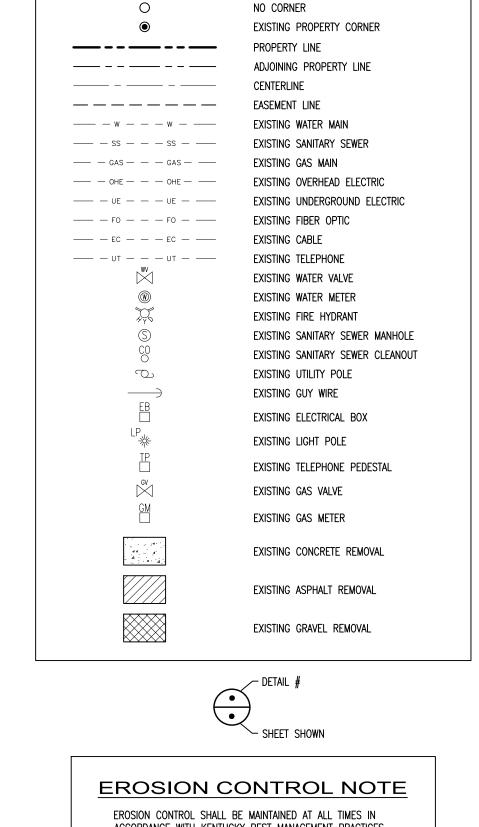

LEGEND

ACCORDANCE WITH KENTUCKY BEST MANAGEMENT PRACTICES AND THE "KENTUCKY EROSION PREVENTION AND SEDIMENT CONTROL FIELD GUIDE".

PHASE 1: TO BE COMPLETE BEFORE NEW BUILDING CONSTRUCTION PHASE 2: TO BE COMPLETE 3-4 MONTHS AFTER START OF NEW


DEMOLITION PHASING

BUILDING CONSTRUCTION (COORDINATE WITH NOC)

GRAPHIC SCALE (IN FEET) 1 INCH = 30 FEET

PROJECT NO.: 23247

DATE: APRIL 16, 2024 DRAWN BY: DJT & MM CHECKED BY: REV. DESCRIPTION

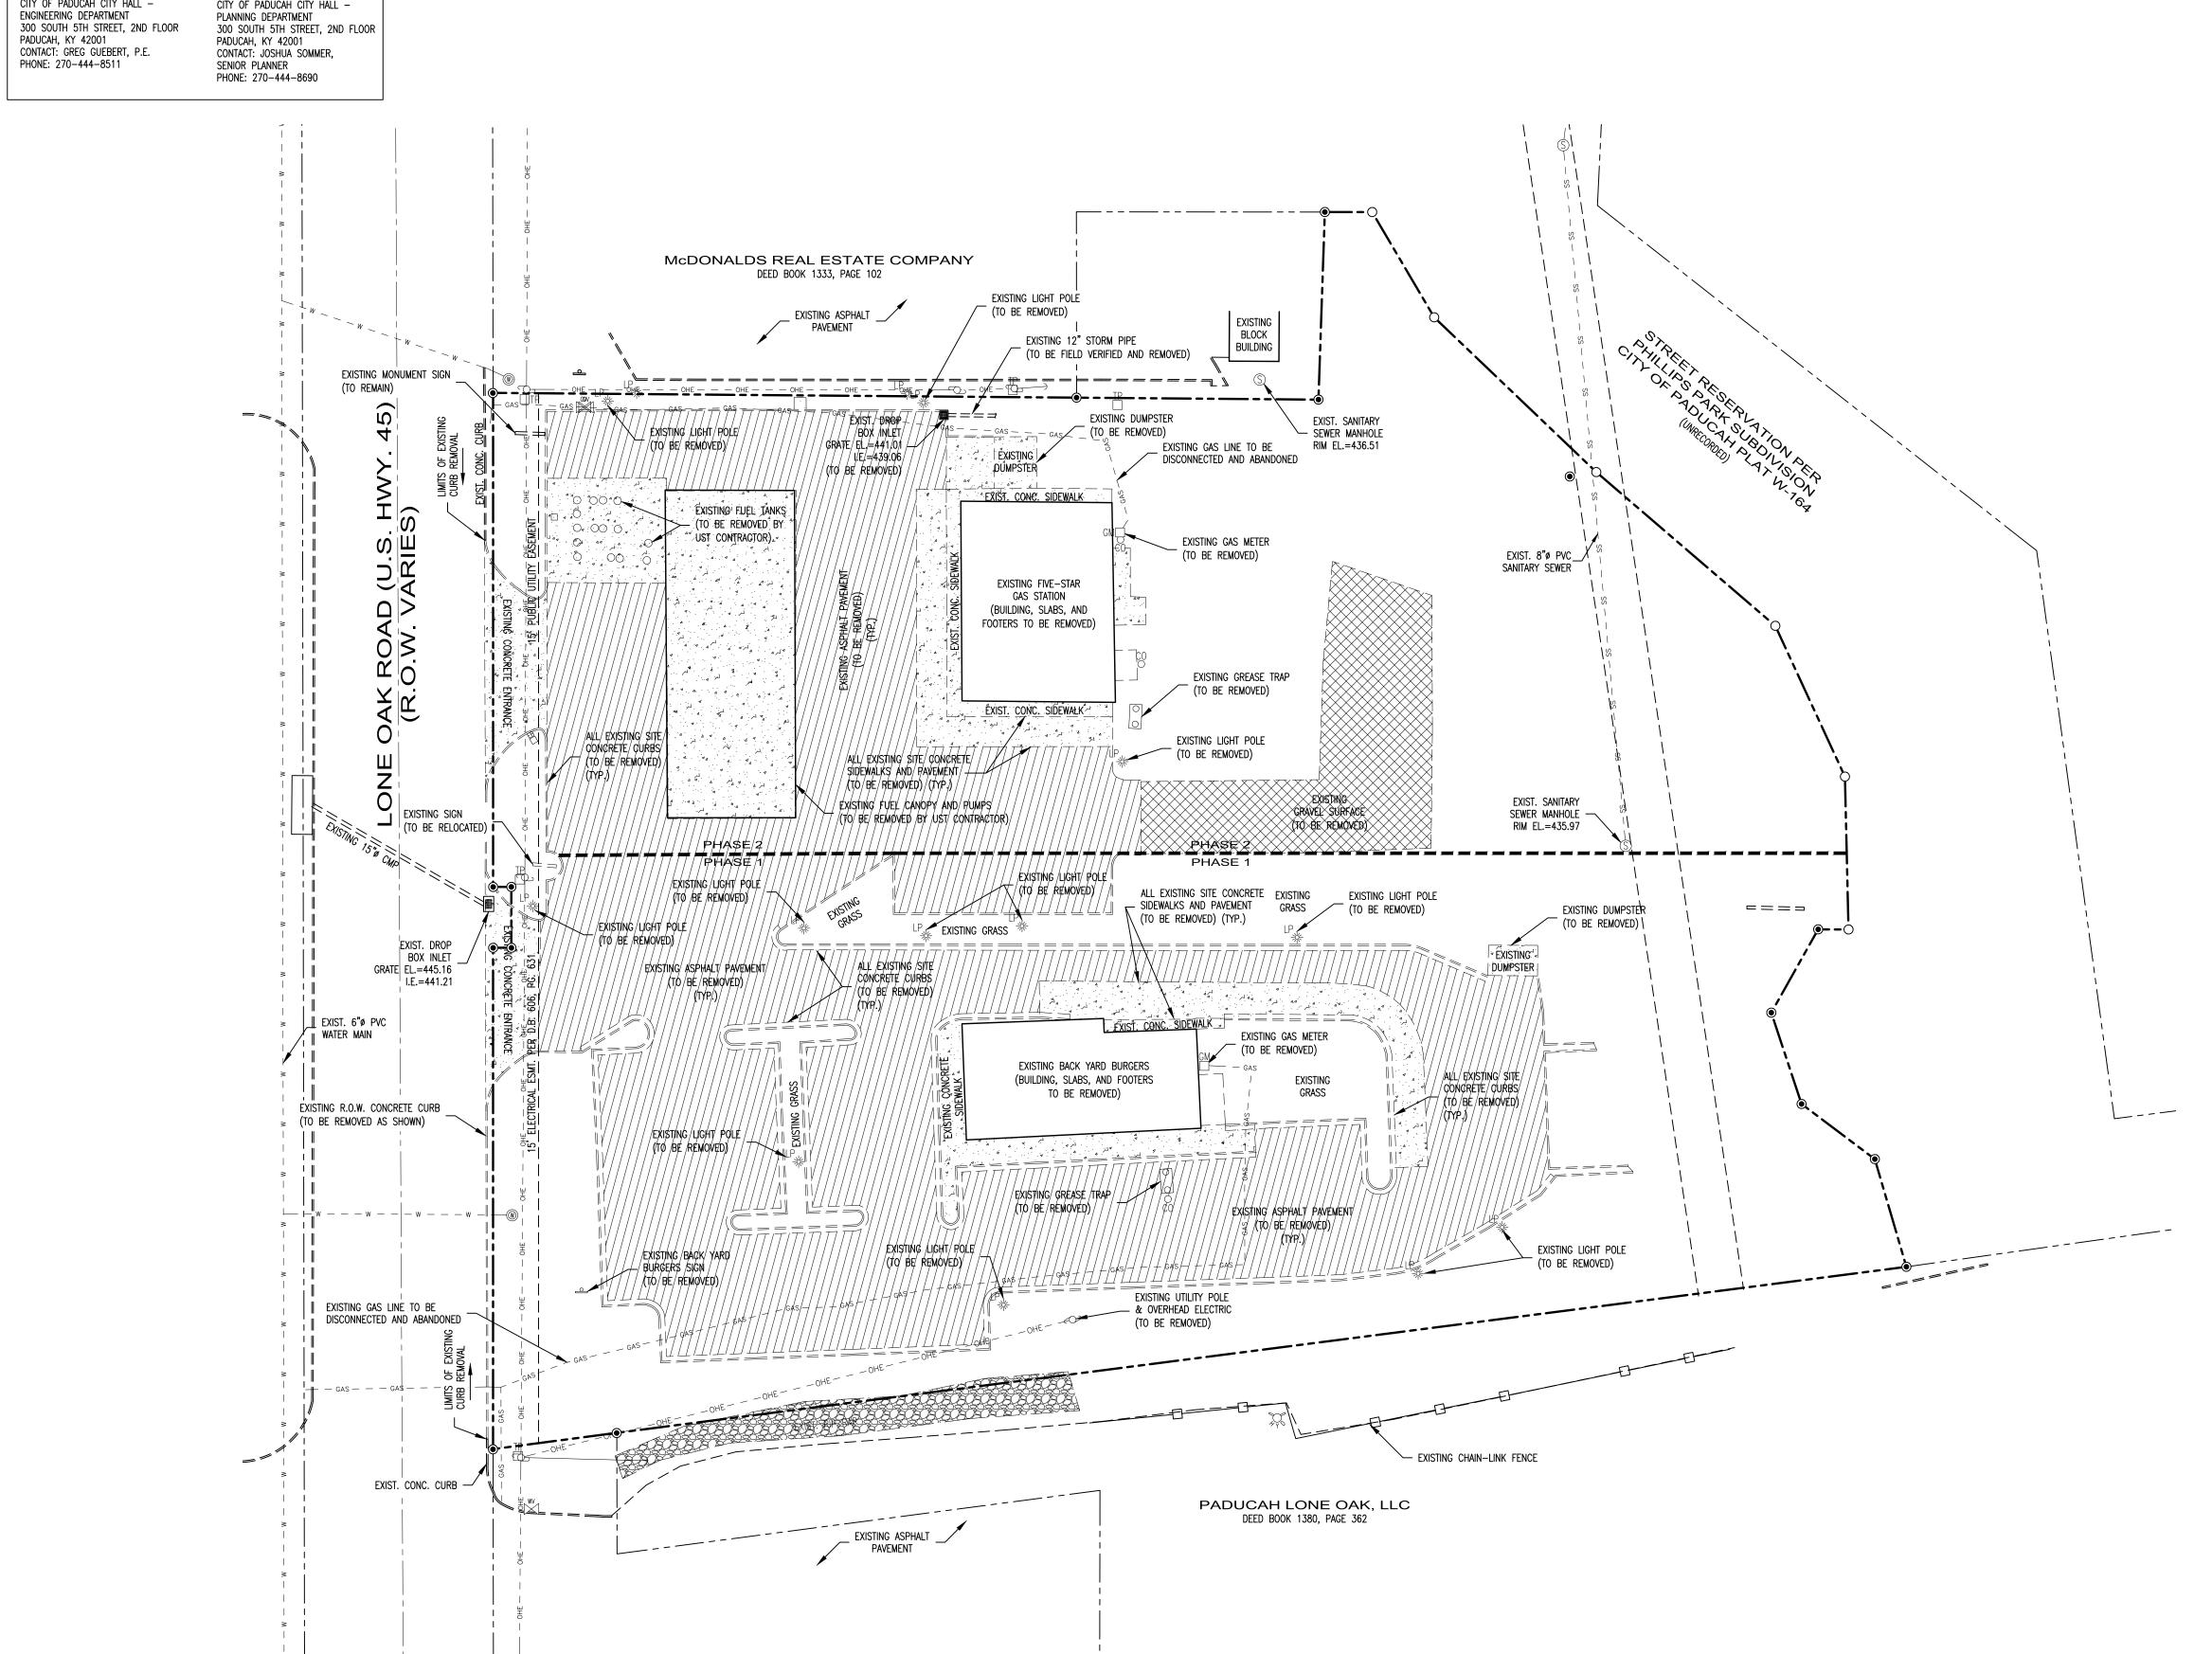

ELECTRIC: PADUCAH POWER 1500 BROADWAY STREET PADUCAH, KY 42001 CONTACT: KERRY FULCHER PHONE: 270-210-4579

810 KENTUCKY AVENUE

CONTACT: ALAN SHELBY

PHONE: 270-444-5048

PADUCAH, KY 42001

TELEPHONE:

ATMOS ENERGY 3510 COLEMAN ROAD PADUCAH, KY 42001 CONTACT: TANNER WILKERSON PHONE: 270-438-2873

SANITARY SEWER
PADUCAH McCRACKEN JSA

621 NORTHVIEW STREET

CONTACT: JOSH WEBB, P.E.

PADUCAH, KY 42001

<u>Water:</u> Paducah water 1800 NORTH 8TH STREET PADUCAH, KY 42001 CONTACT: SCOTT SMITH PHONE: 270-444-5561

<u>CABLE:</u> COMCAST 800 BROADWAY STREET PADUCAH, KY 42001 CONTACT: STEVE PARMLEY PHONE: 270-442-6382

BURIED UTILITIES NOTE

BURIED UTILITIES ARE SHOWN AT THEIR APPROXIMATE LOCATION BASED UPON INFORMATION OBTAINED FROM LOCAL UTILITY COMPANIES AND FIELD EVIDENCE. OTHER BURIED UTILITIES MIGHT EXIST ON THE SUBJECT SITE THAT ARE NOT SHOWN ON THIS DRAWING.

Know what's below. Call before you dig. Call 811 or 800-752-6007 www.kentucky811.org

Two Business Days Before You Dig

IT'S THE LAW

LANDSCAPING

SITE VUA = 66,142 SQUARE FEET LANDSCAPING REQUIRED: 3,307 SQUARE FEET (5% OF TOTAL VUA) LANDSCAPING PROVIDED: 3,480 SQUARE FEET

TREES REQUIRED: 5 TREES FOR THE FIRST 30 PARKING SPACES, PLUS 1 TREE FOR EACH ADDITIONAL 7 SPACES THEREOF. (30% OF REQUIRED TREES SHALL BE PLACED WITHIN THE PERIMETER OF THE ACTUAL PARKING SURFACE.) TREES PROVIDED: 6 TREES (2 TREES WITHIN THE PERIMETER OF THE ACTUAL PARKING SURFACE.)

PARKING SUMMARY

PARKING REQUIRED PER CITY OF PADUCAH ZONING ORDINANCE: RETAIL STORES (6,519 SF): 1 PER 300 GFA = 22 TOTAL = 22

PARKING PROVIDED: REGULAR (10'X18') = 38


HANDICAP PARKING = 2 TOTAL = 40


CERTIFICATE OF OWNERSHIP

I (WE) HEREBY CERTIFY THAT I AM (WE ARE) THE OWNERS OF THE PROPERTY SHOWN AND DESCRIBED HEREON AND THAT I (WE) HEREBY ADOPT THIS SITE PLAN WITH MY (OUR) FREE CONSENT.

SIGNATURE - NEWCOMB OIL CO., LLC


PRINT NAME

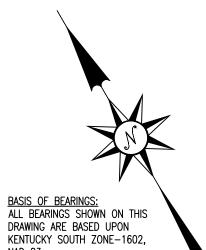

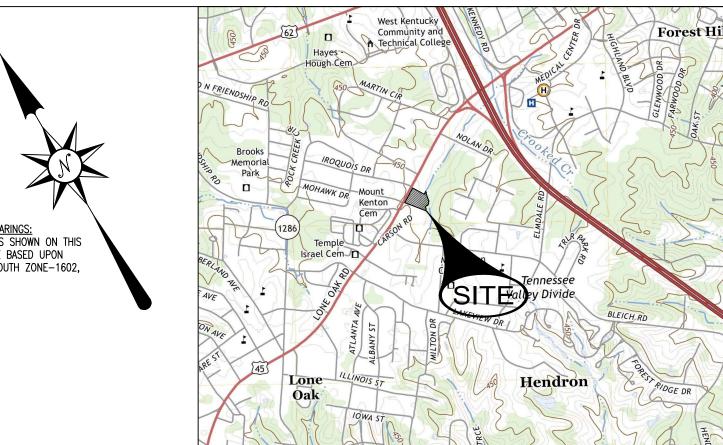

VICINITY MAP SCALE: 1" = 2000'

LEGEND NO CORNER EXISTING PROPERTY CORNER (AS NOTED) PROPERTY LINE _____ ADJOINING PROPERTY LINE CENTERLINE BUILDING SETBACK LINE EASEMENT LINE EXISTING WATER VALVE EXISTING WATER METER EXISTING FIRE HYDRANT EXISTING SANITARY SEWER MANHOLE EXISTING UTILITY POLE EXISTING GUY WIRE EXISTING LIGHT POLE PROPOSED LIGHT POLE PROPOSED TREE PROPOSED LANDSCAPING

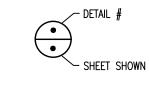

GENERAL SITE NOTES:

- 1. CLIENT: NEWCOMB OIL CO., LLC 951 WITHROW CT.
- BARDSTOWN, KENTUCKY 40004 2. PROPERTY OWNER: NEWCOMB REALTY
- NEWCOMB OIL CO., LLC AND 951 WITHROW CT. 951 WITHROW CT. BARDSTOWN, KENTUCKY 40004 BARDSTOWN, KENTUCKY 40004
- 3. DEED REFERENCE: DEED BOOK 970, PAGE 353 DEED BOOK 1493, PAGE 240
- 4. THE SUBJECT PROPERTY SHOWN HEREON IS LOCATED IN FLOOD ZONE X (AREAS DETERMINED TO BE OUTSIDE THE 0.2% ANNUAL CHANCE FLOODPLAIN) AS SHOWN ON FLOOD INSURANCE RATE MAP FOR McCRACKEN COUNTY, COMMUNITY-PANEL NUMBER 21145C0142F, DATED NOVEMBER 2, 2011.
- 5. TOTAL PROPERTY AREA: 1.77 ACRES (2310 LONE OAK RD.) AND 1.40 ACRES (2314 LONE OAK RD.)
- 6. THIS PROPERTY IS ZONED HBZ, (HIGHWAY BUSINESS ZONE), AND IS SUBJECT TO ALL REGULATIONS SET FORTH FOR THIS ZONE BY THE CITY OF PADUCAH, KENTUCKY ZONING

MINIMUM YARD REQUIREMENTS:

FRONT YARD: 50 FEET, EXCEPT WHERE A PARALLEL ACCESS ROAD IS PROVIDED WITH CONSTRUCTION REQUIREMENTS WHICH MEET THE STANDARDS SIDE YARD: 12 FEET, EXCEPT SIDE YARD THAT ABUTS A RESIDENTIAL ZONE SHALL NOT BE LESS THAN 25 FEET. REAR YARD: 10 FEET, EXCEPT WHERE A COMMERCIAL BUILDING IS SERVICED FROM THE REAR, THEN THERE SHALL BE A REAR YARD NOT LESS THAN 30 FEET: ALSO THE DEPTH OF A REAR YARD WHICH ABUTS

- A RESIDENTIAL ZONE SHALL NOT BE LESS THAN 30 FEET. 7. PROPOSED BUILDING SUMMARY: TOTAL = 6,519 SQ. FT.
- 8. ALL PAVEMENT MARKINGS TO BE 4" WHITE STRIPE.
- 9. IT IS THE RESPONSIBILITY OF THE CONTRACTOR TO REPLACE SIDEWALKS, CURBS, GUTTERS, AND/OR DRIVEWAY ENTRANCE APRONS DAMAGED DURING CONSTRUCTION AT NO ADDITIONAL COST TO THE OWNER.


10. EXISTING ROADWAYS DAMAGED DURING CONSTRUCTION SHALL BE REPAIRED TO A

- CONDITION THAT IS EQUAL TO OR EXCEEDS CURRENT CONDITIONS AT NO ADDITIONAL COST TO THE OWNER. 1. IN ACCORDANCE WITH GENERALLY ACCEPTED CONSTRUCTION PRACTICES. THE CONTRACTOR WILL BE SOLELY AND COMPLETELY RESPONSIBLE FOR CONDITIONS OF THE JOB SITE, INCLUDING SAFETY OF ALL PERSONS AND PROPERTY DURING PERFORMANCE OF THE WORK.
- WORKING HOURS. 12. THE CONTRACTOR IS RESPONSIBLE FOR OBTAINING AND PAYMENT OF ALL PERMITS REQUIRED TO COMPLETE THE PROJECT. ALL MATERIALS AND PROCEDURES SHALL BE IN

THIS REQUIREMENT WILL APPLY CONTINUOUSLY AND WILL NOT BE LIMITED TO NORMAL


- ACCORDANCE WITH CITY OF PADUCAH STANDARDS AND SPECIFICATIONS. 13. A COPY OF THIS APPROVED SITE PLAN AND ALL PERTINENT DOCUMENTS SHALL BE
- READILY AVAILABLE AT THE WORK SITE AT ALL TIMES. 14. BEFORE CONSTRUCTION, THE CONTRACTOR SHOULD CONTACT B.U.D. 1-800-752-6007. 15. ALL WORK WITHIN THE CITY RIGHT OF WAY SHALL REQUIRE A PERMIT ISSUED BY THE
- CITY OF PADUCAH ENGINEERING DEPARTMENT. 16. NOTIFICATION SHALL BE GIVEN TO THE CITY ENGINEER'S OFFICE 72 HOURS PRIOR TO BEGINNING WORK WITHIN THE RIGHT-OF-WAY.
- 17. ALL WORK WITHIN THE STATE RIGHT OF WAY SHALL REQUIRE A PERMIT ISSUED BY THE KENTUCKY TRANSPORTATION CABINET DISTRICT OFFICE.
- 18. ALL DIMENSIONS SHOWN ARE TO FACE OF CURB, UNLESS NOTED OTHERWISE.
- 19. THIS PROPOSED SITE DEVELOPMENT PLAN REMAINS IN COMPLIANCE WITH A PREVIOUS

STORMWATER MANAGEMENT PLAN APPROVED ON AUGUST 6TH, 1998.

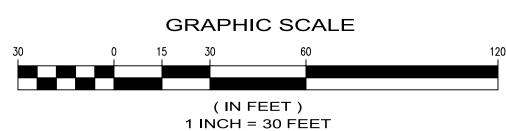

PROJECT NO.: 23247 DATE: APRIL 16, 2024 DRAWN BY: DJT & MM CHECKED BY:

REV. DESCRIPTION

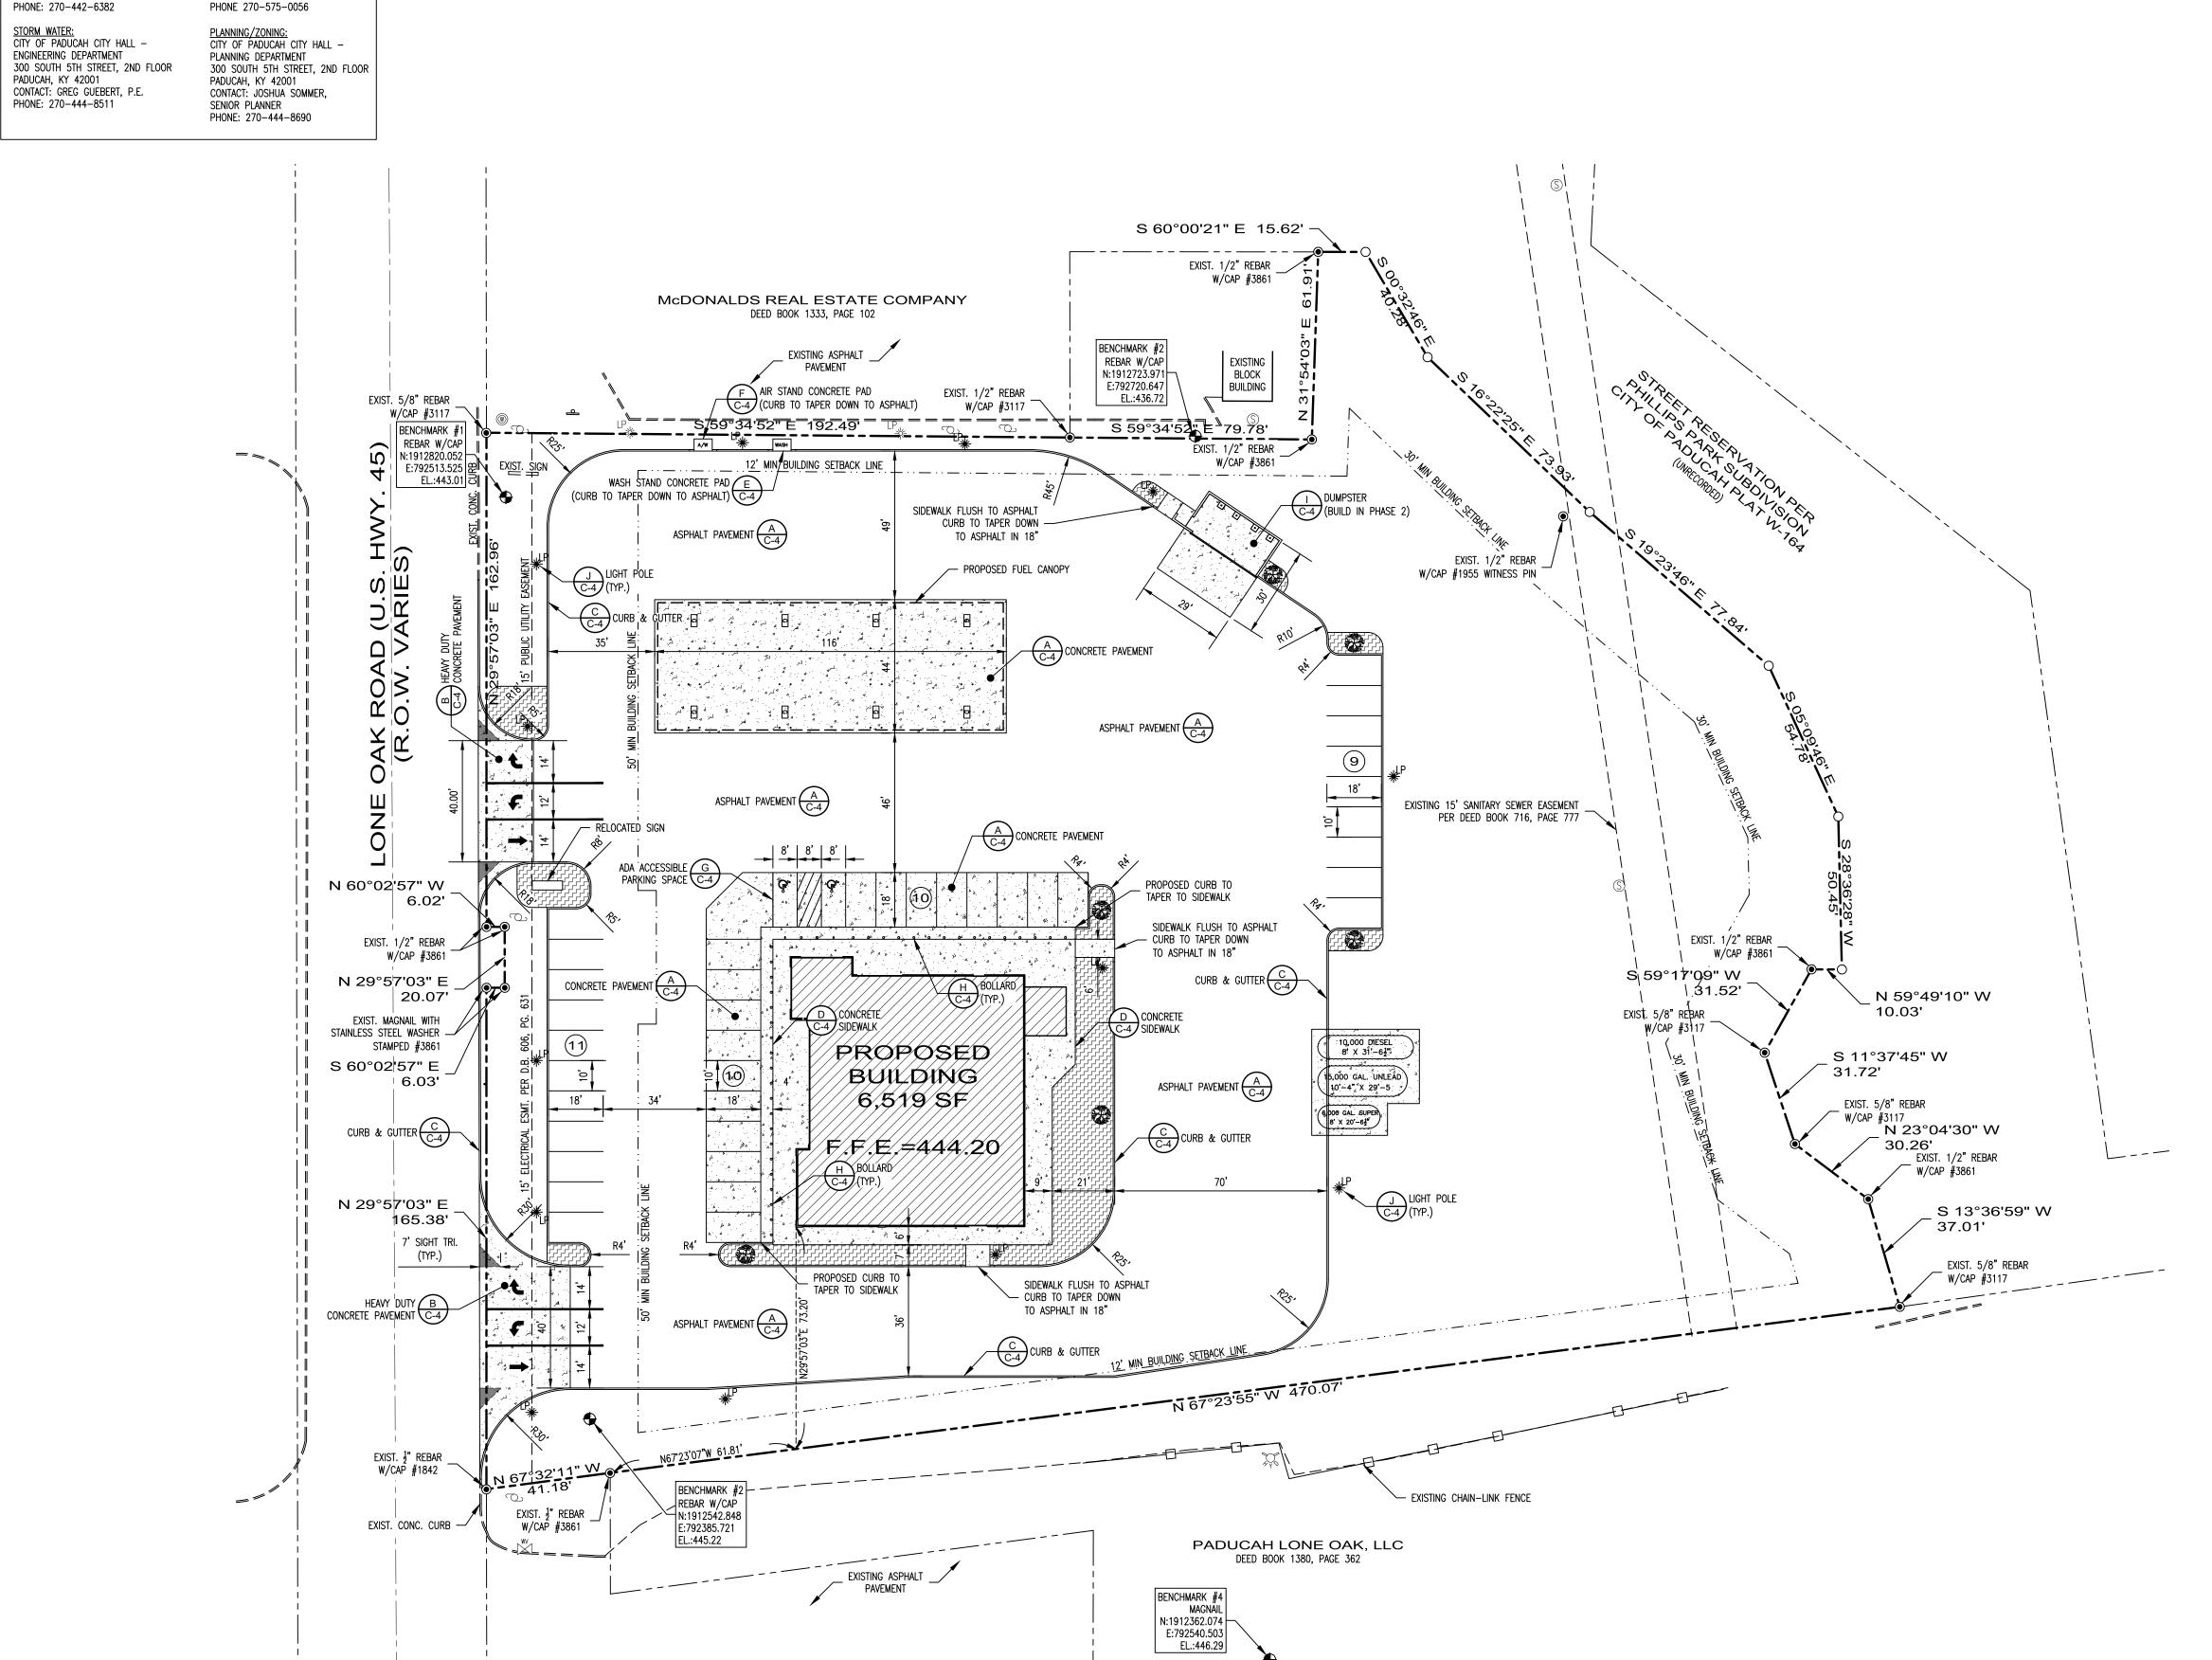

ELECTRIC: PADUCAH POWER 1500 BROADWAY STREET PADUCAH, KY 42001 CONTACT: KERRY FULCHER PHONE: 270-210-4579

810 KENTUCKY AVENUE

CONTACT: ALAN SHELBY

PHONE: 270-444-5048

PADUCAH, KY 42001

TELEPHONE:

ATMOS ENERGY 3510 COLEMAN ROAD PADUCAH, KY 42001 CONTACT: TANNER WILKERSON PHONE: 270-438-2873

PADUCAH WATER 1800 NORTH 8TH STREET PADUCAH, KY 42001 CONTACT: SCOTT SMITH PHONE: 270-444-5561

SANITARY SEWER

PADUCAH McCRACKEN JSA

CONTACT: JOSH WEBB, P.E.

621 NORTHVIEW STREET

PADUCAH, KY 42001

<u>CABLE:</u> COMCAST 800 BROADWAY STREET PADUCAH, KY 42001 CONTACT: STEVE PARMLEY PHONE: 270-442-6382

PHONE 270-575-0056 STORM WATER: CITY OF PADUCAH CITY HALL — CITY OF PADUCAH CITY HALL -ENGINEERING DEPARTMENT PLANNING DEPARTMENT 300 SOUTH 5TH STREET, 2ND FLOOR 300 SOUTH 5TH STREET, 2ND FLOOR PADUCAH, KY 42001 PADUCAH, KY 42001 CONTACT: GREG GUEBERT, P.E. CONTACT: JOSHUA SOMMER, PHONE: 270-444-8511 SENIOR PLANNER

BURIED UTILITIES NOTE

BURIED UTILITIES ARE SHOWN AT THEIR APPROXIMATE LOCATION BASED UPON INFORMATION OBTAINED FROM LOCAL UTILITY COMPANIES AND FIELD EVIDENCE. OTHER BURIED UTILITIES MIGHT EXIST ON THE SUBJECT SITE THAT ARE NOT SHOWN ON THIS DRAWING.

Know what's **below**. Call before you dig. Call 811 or 800-752-6007

www.kentucky811.org

Two Business Days Before You Dig

IT'S THE LAW

EROSION CONTROL

CONSTRUCT STABILIZED CONSTRUCTION ENTRANCE WITHIN HATCHED AREA.

AREA TO BE APPROXIMATELY 50' LONG BY 24' WIDE. PLACE KDOH NO.

C-5 2 STONE A MINIMUM OF 6" DEEP, OVER FILTER FABRIC.

(2) INSTALL PROPOSED SILT FENCE (S)


 \bigcirc INSTALL PROPOSED INLET PROTECTION \bigcirc C-5

DISTURBED AREA

APPROXIMATE AREA = 2.38 ACRES

BASIS OF BEARINGS: ALL BEARINGS SHOWN ON THIS DRAWING ARE BASED UPON KENTUCKY SOUTH ZONE-1602,

LEGEND _______ ______ _____ --- - OHE - - - OHE - ------ - UE - - - UE - ---— - FO - - - FO - — — — EC — — EC — — --- - UT - - - UT - --

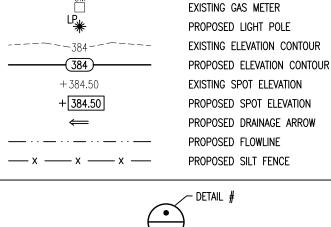

NO CORNER

PROPERTY LINE

EASEMENT LINE

EXISTING WATER MAIN

EXISTING GAS MAIN

EXISTING FIBER OPTIC

EXISTING TELEPHONE

EXISTING WATER VALVE

EXISTING WATER METER

EXISTING FIRE HYDRANT

EXISTING UTILITY POLE EXISTING GUY WIRE

EXISTING ELECTRICAL BOX EXISTING LIGHT POLE

EXISTING GAS VALVE

EXISTING TELEPHONE PEDESTAL

EXISTING SANITARY SEWER MANHOLE

EXISTING SANITARY SEWER CLEANOUT

EXISTING CABLE

EXISTING SANITARY SEWER

EXISTING OVERHEAD ELECTRIC

EXISTING UNDERGROUND ELECTRIC

CENTERLINE

EXISTING PROPERTY CORNER

ADJOINING PROPERTY LINE

SITE GRADING NOTES:

ALL CONTOURS AND SPOT ELEVATIONS INDICATE FINISH GRADE OF SURFACE. ADJUST ACCORDINGLY TO ESTABLISH SUBGRADE OR SUB-BASE ELEVATIONS.

➤ SHEET SHOWN

PRIOR TO BEGINNING CONSTRUCTION, CONTRACTOR SHALL BE RESPONSIBLE FOR VERIFYING AND FIELD LOCATING ALL UTILITIES WITHIN THE PROJECT LIMITS SO THAT CONSTRUCTION WILL NOT DAMAGE OR INTERFERE WITH EXISTING UTILITY LINES. IF ANY UTILITY LINES ARE DAMAGED, IT IS THE CONTRACTOR'S RESPONSIBILITY TO REPAIR AND/OR REPLACE THE UTILITY LINES AT THE CONTRACTOR'S EXPENSE. FINISHED REPLACEMENT OR REPAIR SHALL MEET THE APPROVAL OF THE SPECIFIC UTILITY

BEFORE STARTING SITE EXCAVATION, CONTRACTOR SHALL STRIP ALL TOPSOIL FROM THE PROJECT AREA AND STORE IN A PROTECTED LOCATION THAT SHALL NOT INTERFERE WITH PROJECT DEVELOPMENT. CONTRACTOR SHALL BE RESPONSIBLE FOR REDISTRIBUTING TOPSOIL IN FINISH GRADE AREAS.

ALL FILL AREAS SHALL BE COMPACTED TO A MINIMUM OF 95% OF THE MAXIMUM DRY DENSITY PER STANDARD PROCTOR ANALYSIS ASTM D 698 OR TO THE PROJECT SPECIFICATIONS, WHICHEVER IS GREATER.

CONTRACTOR SHALL COORDINATE HORIZONTAL AND VERTICAL CONTROL WITH ENGINEER OR SURVEYOR PRIOR TO COMMENCEMENT OF CONSTRUCTION.

UTILITIES SHOWN ARE THOSE VISIBLE AT THE TIME OF MAPPING. UNDERGROUND UTILITIES SHOWN WERE LOCATED BY OBSERVATION OF SURFACE FEATURES. LOCATION OF UNDERGROUND UTILITIES ARE APPROXIMATE AT BEST. UNMARKED UNDERGROUND UTILITIES MAY BE PRESENT. CONTACT UTILITY OWNERS PRIOR TO EXCAVATION OR

ALL DISTURBED AREAS NOT TO RECEIVE PAVEMENT SHALL BE FINE GRADED TO DRAIN, BACKFILLED WITH A MINIMUM OF 6" TOPSOIL, SEEDED OR SODDED, FERTILIZED, AND PROTECTED PER STANDARD KDOH SPECIFICATIONS. CONTRACTOR IS RESPONSIBLE FOR RE-SEEDING AND/OR RE-SODDING UNTIL THE INITIAL STAND OF GRASS HAS BEEN ESTABLISHED.

BENCHMARK INFORMATION AS PROVIDED SHALL BE USED TO CONFIRM EXISTING TOPOGRAPHIC CONDITIONS PRIOR TO THE COMMENCEMENT OF ANY CONSTRUCTION ACTIVITIES. ANY CONFLICT AND/OR DISCREPANCIES ENCOUNTERED BETWEEN THE EXISTING TOPOGRAPHY SHOWN AND ACTUAL SITE CONDITIONS SHALL BE REPORTED TO THE OWNER AND ENGINEER IMMEDIATELY.

ANY EXCESS SOIL SHALL BE EXPORTED FROM THE SITE BY THE CONTRACTOR AT NO ADDITIONAL COST TO THE OWNER. ANY FILL MATERIAL REQUIRED TO BE IMPORTED TO THE SITE FOR PROPER GRADING AND FINISHING OF PROPOSED SITE ELEVATIONS SHALL BE APPROVED BY THE OWNER PRIOR TO PLACEMENT AND COMPACTION.

10. THE CONTRACTOR SHALL NOT SCALE FROM THESE PLANS FOR FIELD SURVEY

IMPROPER GRADING/FINISHING OF CONCRETE OR ASPHALT SURFACES WITHIN THE PROJECT LIMITS OR ADJACENT RIGHTS-OF-WAY THAT RESULTS IN DRAINAGE PROBLEMS SHALL BE REMOVED AND REINSTALLED TO IMPLEMENT POSITIVE DRAINAGE.


2. THE CONTRACTOR IS RESPONSIBLE FOR SEDIMENTATION CONTROL OF ONSITE RUNOFF IN ACCORDANCE WITH "KENTUCKY BEST MANAGEMENT" PRACTICES. PERIMETER OF DRAINAGE AREA TO RECEIVE SILT FENCE AND ALL CHANNEL WAYS TO RECEIVE ROCK

3. ALL DITCHES DISTURBED DURING CONSTRUCTION SHALL BE RETURNED TO THEIR ORIGINAL LINES AND GRADES. THE IMPROVEMENT OF THIS SITE SHALL NOT DETOUR OR OBSTRUCT THE NECESSARY DRAINAGE REQUIRED.

4. THE DRAINAGE PATTERN CREATED BY THE DEVELOPMENT OF THIS SITE SHALL BE CONSISTENT WITH THE PREVIOUS STORMWATER DRAINAGE PATTERNS. THE ADJACENT PROPERTY OWNERS SHALL NOT REALIZE ANY CHANGE IN RUNOFF TO THEIR PROPERTY.

5. ALL POTENTIAL EROSION SHALL BE CONTROLLED IN SUCH A MANNER SO AS TO PREVENT ANY DISPLACEMENT OF SILT TO THE ADJACENT PROPERTY OWNERS OR RIGHT-OF-WAY. THIS CONTROL SHALL BE IMPLEMENTED THROUGH PROPER INSTALLATION OF SILT FENCE OR STRAW BALES DURING THE CONSTRUCTION DURATION AND MAINTAINED UNTIL PROPER GROUND COVER HAS BEEN ESTABLISHED.

16. ALL PROPOSED SPOT ELEVATIONS SHOWN AT CURBS INDICATE THE PAVEMENT

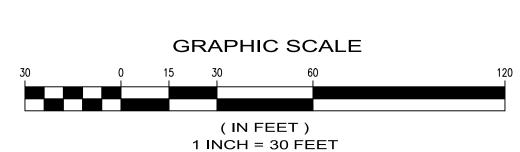



PROJECT NO.: 23247 DATE: APRIL 16, 2024

DRAWN BY: DJT & MM CHECKED BY: REV. DESCRIPTION

SHEET

PHONE: 270-444-8690 RIM EL.=434.71-I.E.=422.06¹ McDONALDS REAL ESTATE COMPANY DEED BOOK 1333, PAGE 102 BENCHMARK #2 EXISTING ASPHALT EXISTING REBAR W/CAP PAVEMENT BLOCK E:792720.647 BUILDING EL.:436.72 REBAR W/CAP 1 N:1912820.052 E:792513.525 문 EL.:443.01 RIM EL.=436.51 — EXISTING FLOWLINE SANITARY SEWER FUEL CANOPY DRAIN PIPE BY UST CONTRACTOR GRATE EL.=437.62 I.E.=435.12 PIPE BEDDING (TYP.) 94 LF - NEW 15" ADS N-12 @ 3.31% SLOPE (43**4.**74+) 434.70 EXIST. SANITARY SEWER MANHOLE -RIM EL.=435.97 / I.E.=431.28 -CONVERT EXIST. GRATE INLET TO A CURB INLET TYPE A EXIST. GRATE EL.=445.16 I.E.=441.21 NEW DBI#1 GRATE EL.=442.01 I.E.=439.26 EXISTING EARTHEN WEIR I ∥ EXIST. 6"ø PVC EXISTING FLOWLINE BUILDING II WATER MAIN 6,519/SF _F/F/E/≠#44/20 NEW DBI#3
GRATE EL.=439.30
I.E.=436.55 N PIRE BEDDING (TYP.) 十439.31 BUILDING DRAIN PIPE BY BUILDING CONTRACTOR - Proposéd Ridge - EXISTING FLOWLINE X EXISTING CONCRETE ろ BENCHMARK #2 — EXISTING CHAIN—LINK FENCE REBAR W/CAP N:1912542.848 EXIST. CONC. CURB E:792385.721 PADUCAH LONE OAK, LLC DEED BOOK 1380, PAGE 362 EXISTING ASPHALT PAVEMENT BENCHMARK #

MAGNÁIL

EL.:446.29

N:1912362.074 E:792540.503

ELECTRIC: PADUCAH POWER 1500 BROADWAY STREET PADUCAH, KY 42001 CONTACT: KERRY FULCHER PHONE: 270-210-4579

810 KENTUCKY AVENUE

CONTACT: ALAN SHELBY

PHONE: 270-444-5048

PHONE: 270-444-8511

PADUCAH, KY 42001

TELEPHONE:

ATMOS ENERGY 3510 COLEMAN ROAD PADUCAH, KY 42001 CONTACT: TANNER WILKERSON PHONE: 270-438-2873

<u>Water:</u> Paducah water 1800 NORTH 8TH STREET PADUCAH, KY 42001 CONTACT: SCOTT SMITH PHONE: 270-444-5561

<u>CABLE:</u> COMCAST 800 BROADWAY STREET PADUCAH, KY 42001 CONTACT: STEVE PARMLEY PHONE: 270-442-6382

STORM WATER: CITY OF PADUCAH CITY HALL — ENGINEERING DEPARTMENT 300 SOUTH 5TH STREET, 2ND FLOOR PADUCAH, KY 42001 CONTACT: GREG GUEBERT, P.E.

SANITARY SEWER
PADUCAH McCRACKEN JSA 621 NORTHVIEW STREET PADUCAH, KY 42001 CONTACT: JOSH WEBB, P.E. PHONE 270-575-0056

> PLANNING/ZONING: CITY OF PADUCAH CITY HALL -PLANNING DEPARTMENT 300 SOUTH 5TH STREET, 2ND FLOOR PADUCAH, KY 42001 CONTACT: JOSHUA SOMMER, SENIOR PLANNER PHONE: 270-444-8690


BURIED UTILITIES NOTE

BURIED UTILITIES ARE SHOWN AT THEIR APPROXIMATE LOCATION BASED UPON INFORMATION OBTAINED FROM LOCAL UTILITY COMPANIES AND FIELD EVIDENCE. OTHER BURIED UTILITIES MIGHT EXIST ON THE SUBJECT SITE THAT ARE NOT SHOWN ON THIS DRAWING.

Know what's below. Call before you dig. Call 811 or 800-752-6007

www.kentucky811.org Two Business Days Before You Dig IT'S THE LAW

BASIS OF BEARINGS: ALL BEARINGS SHOWN ON THIS DRAWING ARE BASED UPON KENTUCKY SOUTH ZONE-1602,

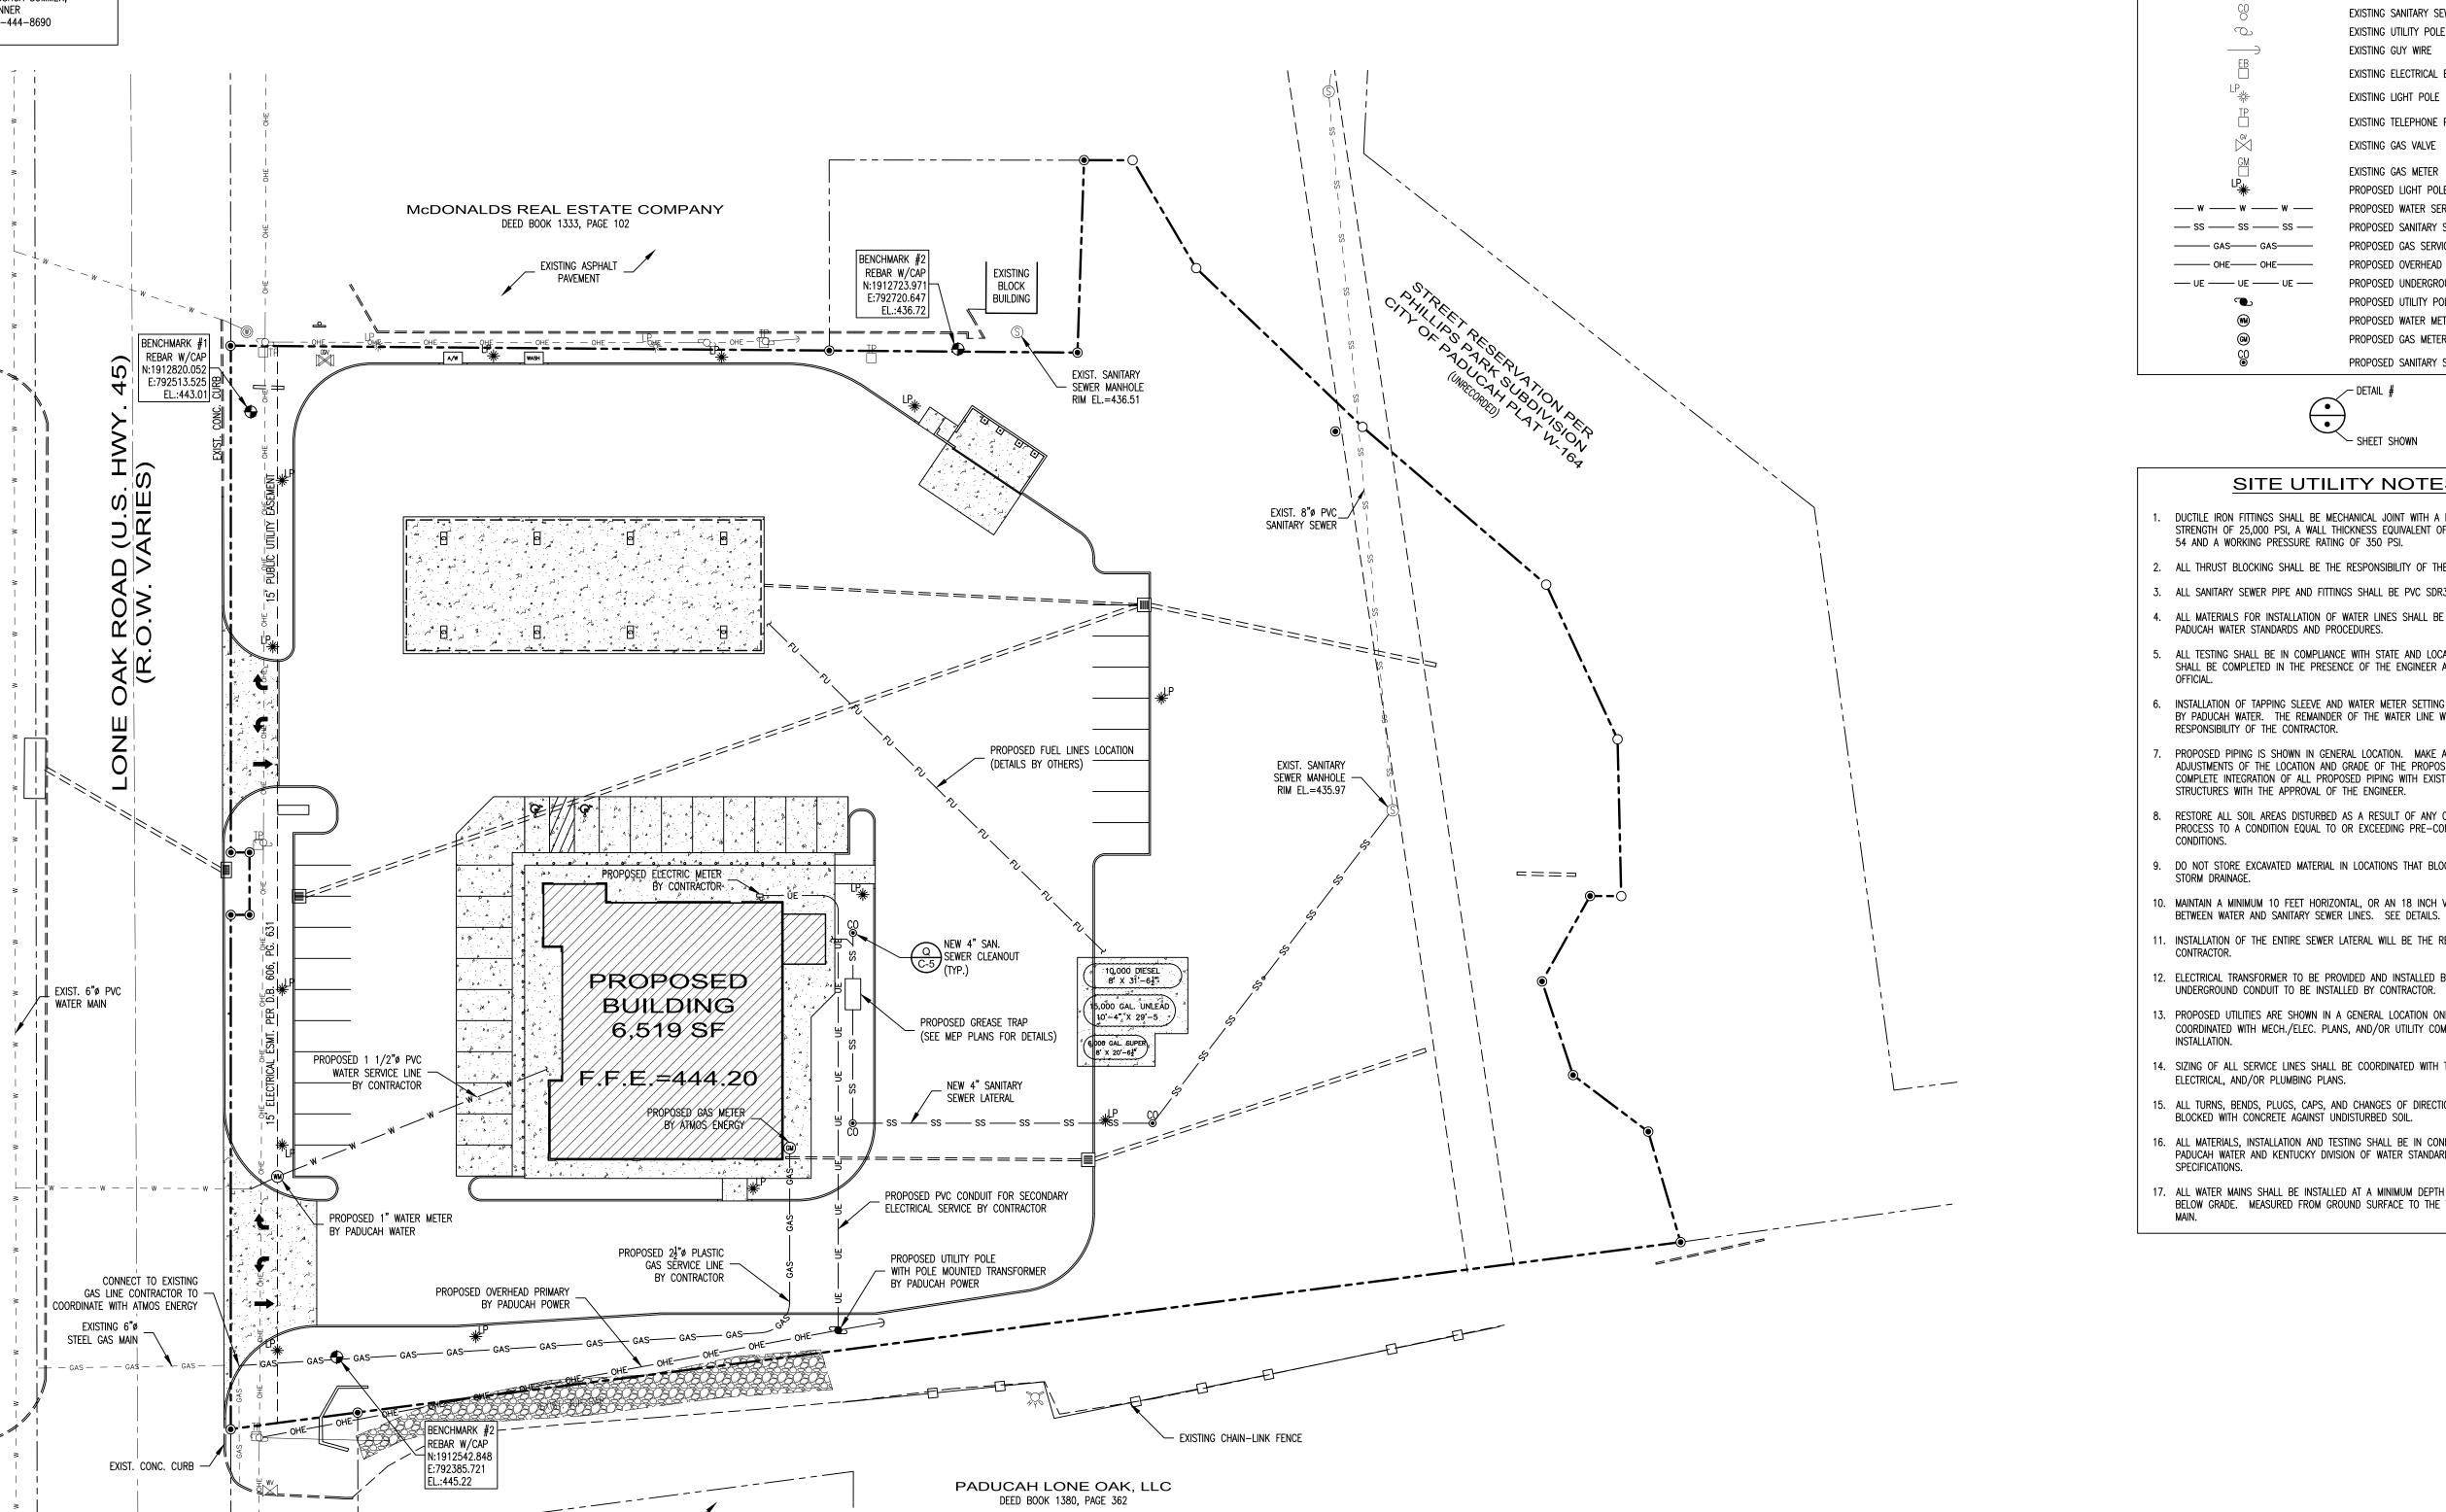

BENCHMARK # MAGNÁIL


N:1912362.074 E:792540.503

EL.:446.29

PAVEMENT

LEGEND

NO CORNER EXISTING PROPERTY CORNER PROPERTY LINE ADJOINING PROPERTY LINE _______ CENTERLINE ______ EASEMENT LINE _____ ____ _ w _ _ _ w _ _ _ EXISTING WATER MAIN EXISTING SANITARY SEWER EXISTING GAS MAIN EXISTING OVERHEAD ELECTRIC --- - OHE - - - OHE - ---EXISTING UNDERGROUND ELECTRIC --- - UE - - - UE - ---EXISTING FIBER OPTIC — - FO - - - FO - — --- – UT - – UT - --EXISTING TELEPHONE EXISTING WATER VALVE EXISTING WATER METER EXISTING FIRE HYDRANT EXISTING SANITARY SEWER MANHOLE EXISTING SANITARY SEWER CLEANOUT EXISTING UTILITY POLE EXISTING GUY WIRE EXISTING ELECTRICAL BOX EXISTING LIGHT POLE EXISTING TELEPHONE PEDESTAL EXISTING GAS VALVE EXISTING GAS METER PROPOSED LIGHT POLE — w — w — w — PROPOSED WATER SERVICE PROPOSED SANITARY SEWER SERVICE — ss —— ss —— ss — PROPOSED GAS SERVICE ——— GAS——— GAS——— PROPOSED OVERHEAD ELECTRIC ----- OHE-----— UE —— UE —— UE — PROPOSED UNDERGROUND ELECTRIC PROPOSED UTILITY POLE PROPOSED WATER METER PROPOSED GAS METER

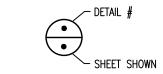

PROPOSED SANITARY SEWER CLEANOUT

SITE UTILITY NOTES:

- DUCTILE IRON FITTINGS SHALL BE MECHANICAL JOINT WITH A MINIMUM TENSILE STRENGTH OF 25,000 PSI, A WALL THICKNESS EQUIVALENT OF DUCTILE IRON CLASS 54 AND A WORKING PRESSURE RATING OF 350 PSI.
- 2. ALL THRUST BLOCKING SHALL BE THE RESPONSIBILITY OF THE CONTRACTOR.
- 3. ALL SANITARY SEWER PIPE AND FITTINGS SHALL BE PVC SDR35.
- 4. ALL MATERIALS FOR INSTALLATION OF WATER LINES SHALL BE IN ACCORDANCE WITH PADUCAH WATER STANDARDS AND PROCEDURES.
- ALL TESTING SHALL BE IN COMPLIANCE WITH STATE AND LOCAL REGULATIONS AND SHALL BE COMPLETED IN THE PRESENCE OF THE ENGINEER AND, OR, A LOCAL
- INSTALLATION OF TAPPING SLEEVE AND WATER METER SETTING WILL BE COMPLETED BY PADUCAH WATER. THE REMAINDER OF THE WATER LINE WILL BE THE RESPONSIBILITY OF THE CONTRACTOR.
- PROPOSED PIPING IS SHOWN IN GENERAL LOCATION. MAKE ALL MINOR ADJUSTMENTS OF THE LOCATION AND GRADE OF THE PROPOSED PIPING TO INSURE COMPLETE INTEGRATION OF ALL PROPOSED PIPING WITH EXISTING PIPING AND STRUCTURES WITH THE APPROVAL OF THE ENGINEER.
- RESTORE ALL SOIL AREAS DISTURBED AS A RESULT OF ANY CONSTRUCTION PROCESS TO A CONDITION EQUAL TO OR EXCEEDING PRE-CONSTRUCTION
- 9. DO NOT STORE EXCAVATED MATERIAL IN LOCATIONS THAT BLOCK THE EXISTING
- 10. MAINTAIN A MINIMUM 10 FEET HORIZONTAL, OR AN 18 INCH VERTICAL SEPARATION
- INSTALLATION OF THE ENTIRE SEWER LATERAL WILL BE THE RESPONSIBILITY OF THE
- 12. ELECTRICAL TRANSFORMER TO BE PROVIDED AND INSTALLED BY PADUCAH POWER. UNDERGROUND CONDUIT TO BE INSTALLED BY CONTRACTOR.
- 13. PROPOSED UTILITIES ARE SHOWN IN A GENERAL LOCATION ONLY AND SHOULD BE COORDINATED WITH MECH./ELEC. PLANS, AND/OR UTILITY COMPANIES PRIOR TO
- 14. SIZING OF ALL SERVICE LINES SHALL BE COORDINATED WITH THE MECHANICAL, ELECTRICAL, AND/OR PLUMBING PLANS.
- 15. ALL TURNS, BENDS, PLUGS, CAPS, AND CHANGES OF DIRECTION SHALL BE BLOCKED WITH CONCRETE AGAINST UNDISTURBED SOIL.
- ALL MATERIALS, INSTALLATION AND TESTING SHALL BE IN CONFORMANCE WITH PADUCAH WATER AND KENTUCKY DIVISION OF WATER STANDARDS AND


GRAPHIC SCALE

(IN FEET) 1 INCH = 30 FEET

. ALL WATER MAINS SHALL BE INSTALLED AT A MINIMUM DEPTH OF 42 INCHES BELOW GRADE. MEASURED FROM GROUND SURFACE TO THE TOP OF THE WATER

PROJECT NO.: 23247

DATE: APRIL 16, 2024 DRAWN BY: DJT & MM CHECKED BY: REV. DESCRIPTION

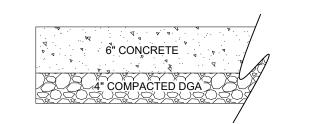

1-1/4" SURFACE COAT


3" BASE COAT

8" COMPACTED DGA

CONCRETE PAVEMENT

ASPHALT PAVEMENT (STANDARD)

A PAVEMENT DETAIL SCALE: N.T.S.

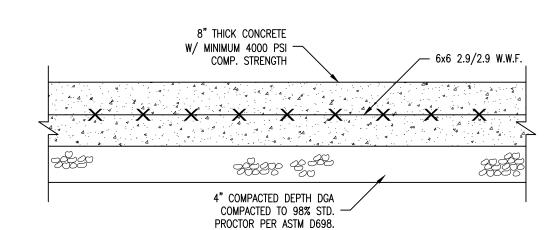


C C-4 CURB DETAIL SCALE: N.T.S.


SEE PAVEMENT SCHEDULE

12" CURB & GUTTER


(STANDARD)

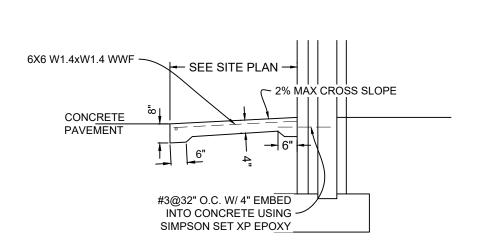

D SIDEWALK DETAIL SCALE: N.T.S.

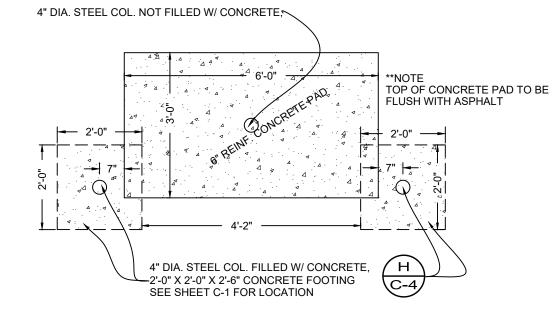


E WASH STAND CONC. PAD SCALE: N.T.S.

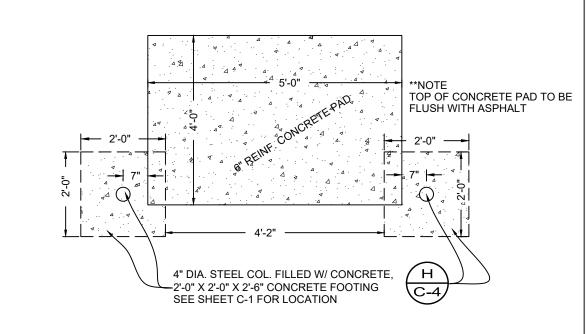


F AIR STAND CONC. PAD SCALE: N.T.S.




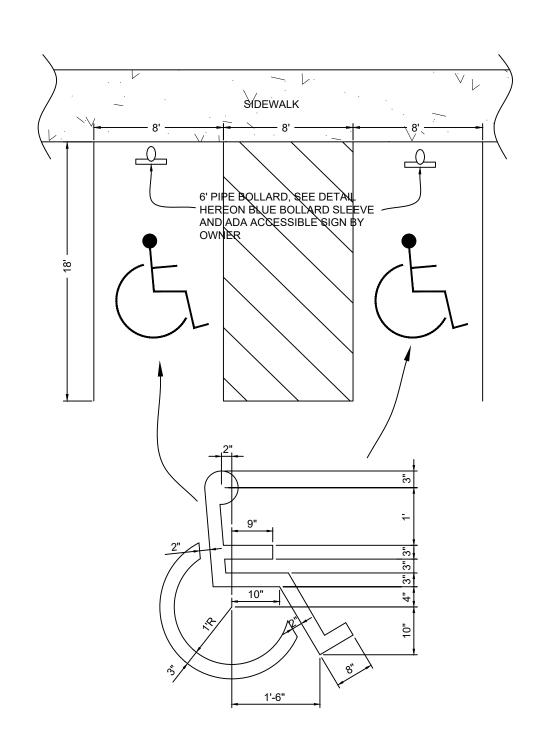


G ADA ACCESSIBLE SPACE DETAIL SCALE: N.T.S.

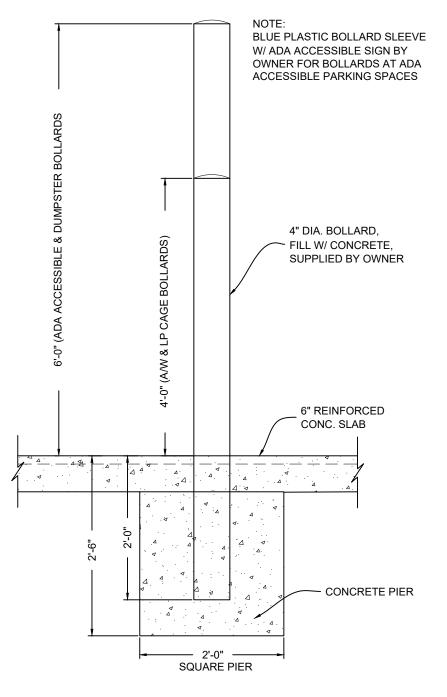


H PIPE BOLLARD DETAIL SCALE: N.T.S.

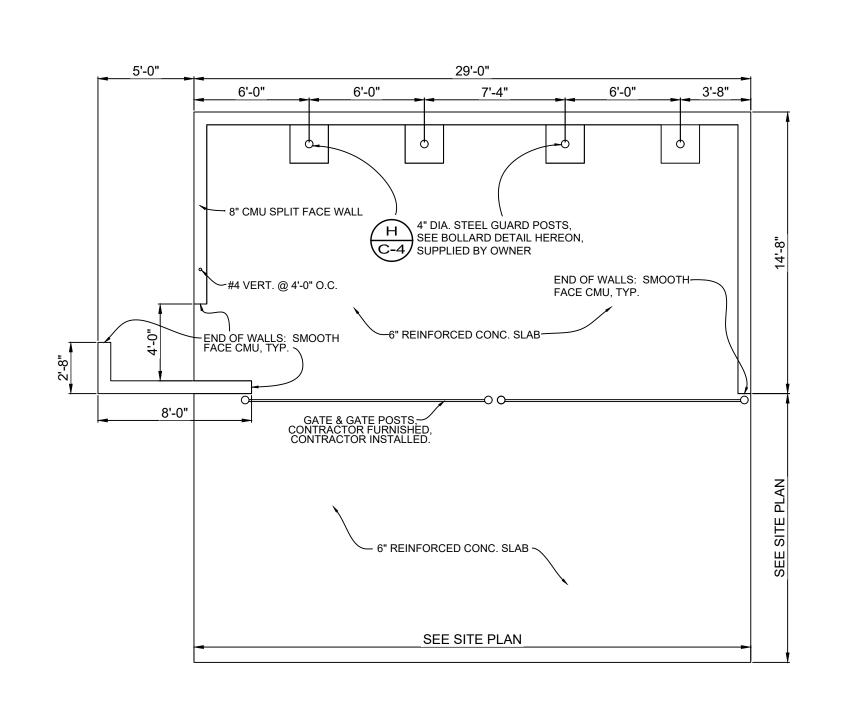



DUMPSTER DETAIL SCALE: N.T.S.

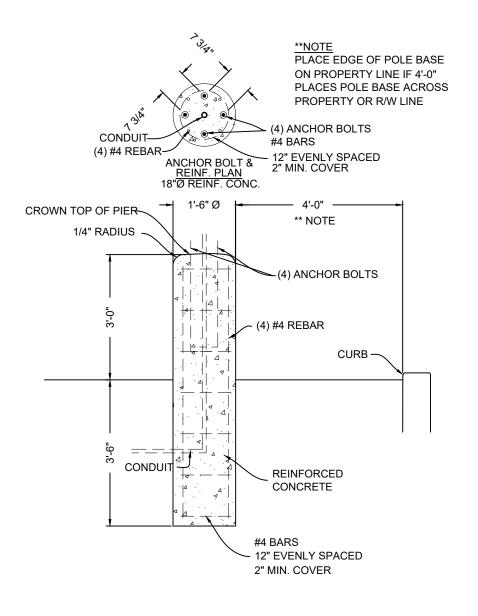

J LIGHT POLE BASE DETAIL SCALE: N.T.S.

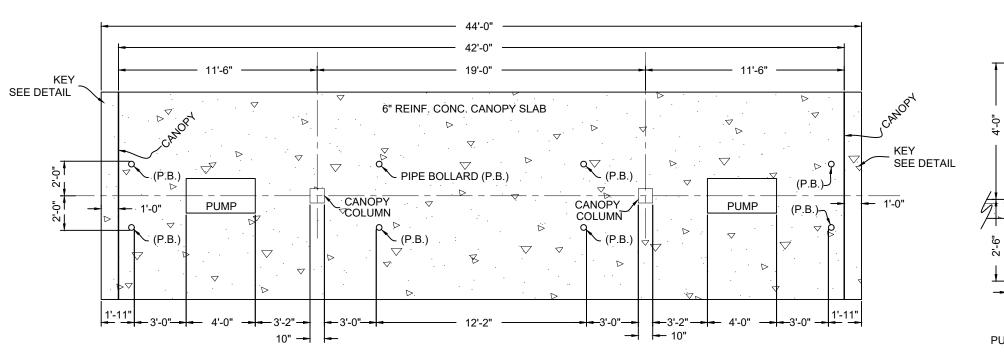

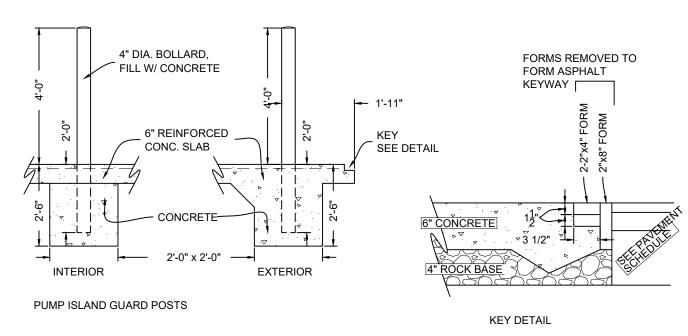

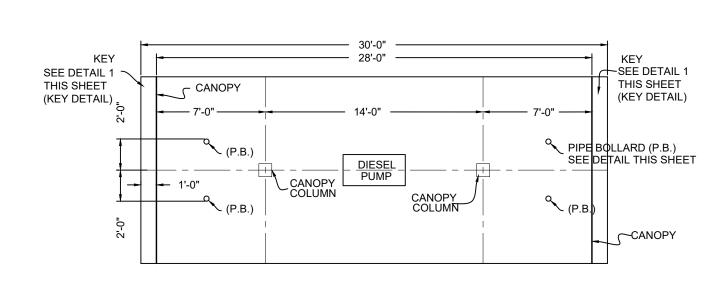

L DIESEL PUMP ISLAND PLAN SECTION SCALE: N.T.S.



SHEET

C-4

PROJECT NO.: 23247

DATE: APRIL 16, 2024


DRAWN BY: DJT & MM


REV. DESCRIPTION


CHECKED BY:

SURVEY & DESIGN, LLC
124 South 31st Street - Paducah, KY 42001 - Ph: (270) 443-8491

4-16-24

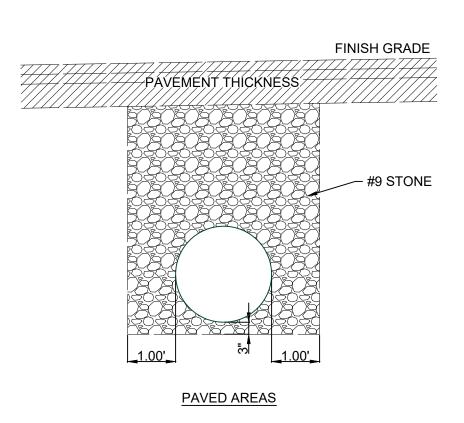


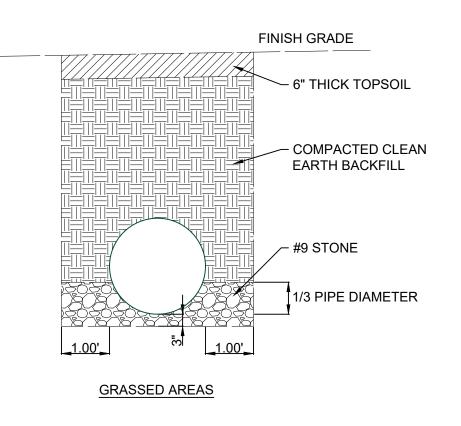

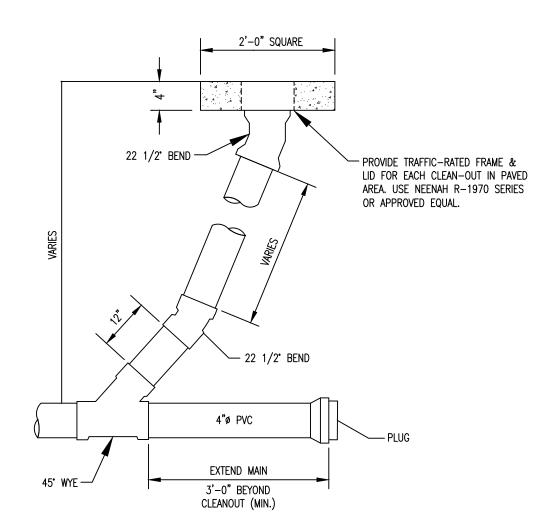

C-5 CLEAN-OUT SCALE: N.T.S.


N PIPE BEDDING DETAIL C-5 SCALE: N.T.S.

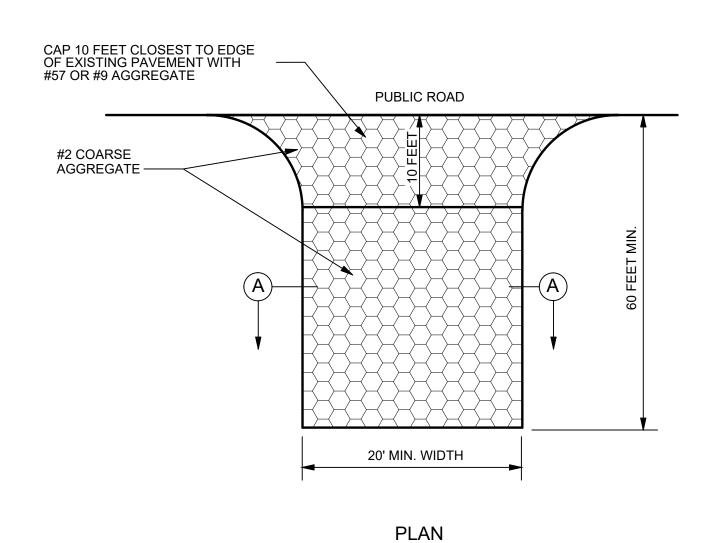


6 INCH MIN. THICKNESS

SECTION A

TEMPORARY GRAVEL C-5 CONSTRUCTION ENTRACE/EDXIT PAD SCALE: N.T.S.

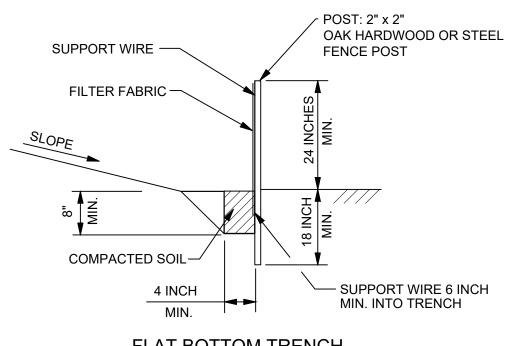


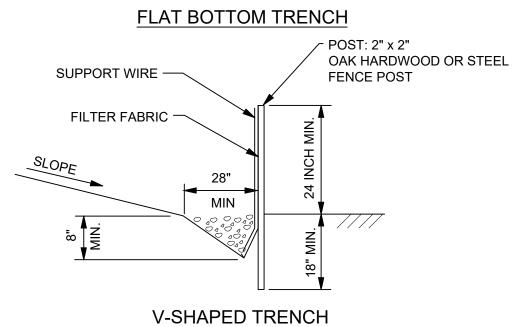


WITH GRAVEL

POST SPACING: 8 FEET WITH WIRE BACKING STANDARD STRENGTH FABRIC 6 FEET WITH NO WIRE BACKING EXTRA STRENGTH FABRIC

SILT FENCE C-5 SCALE: N.T.S.

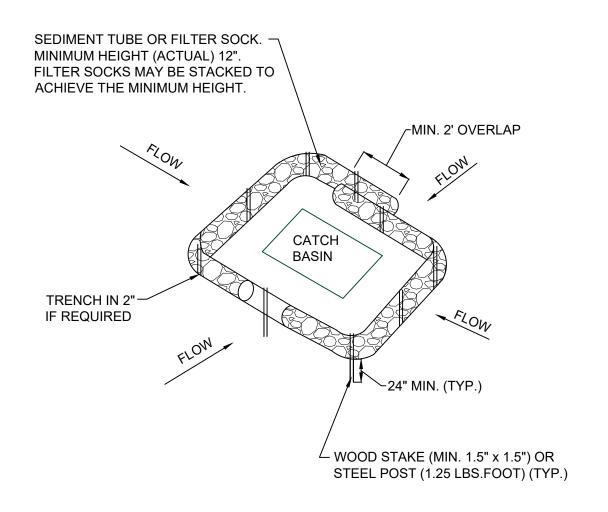

T INLET PROTECTION SCALE: N.T.S.

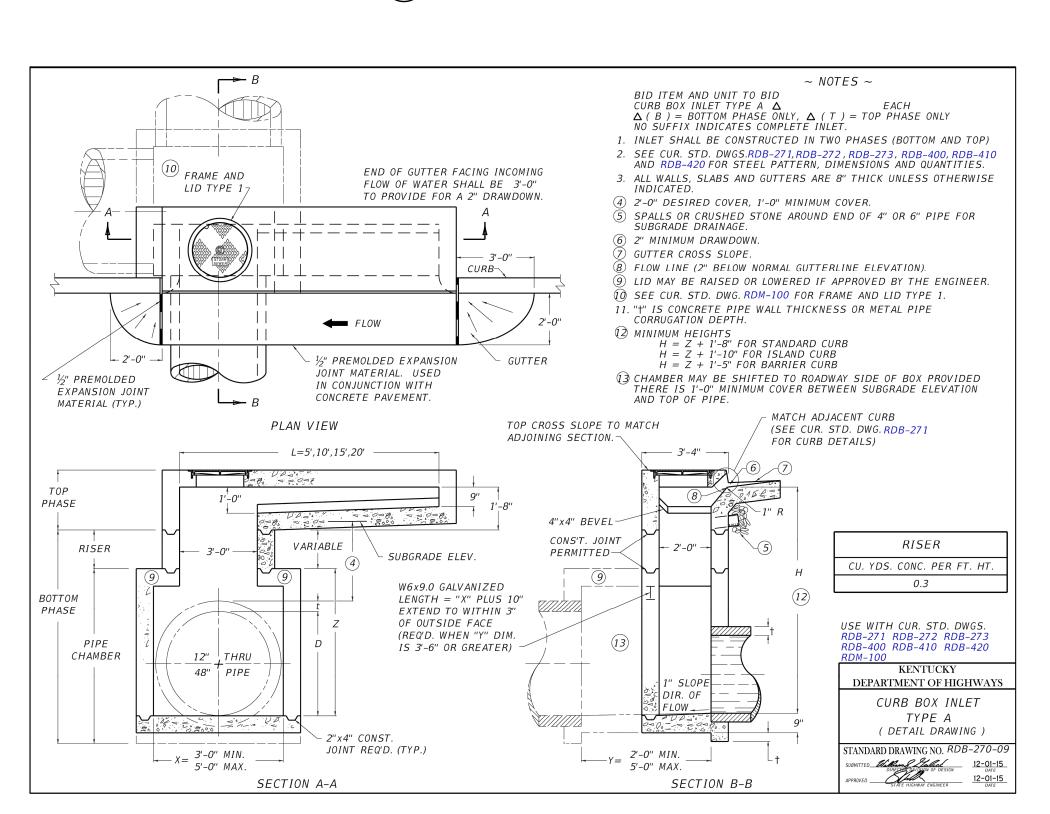



PROJECT NO.: 23247 DATE: APRIL 16, 2024 DRAWN BY: DJT & MM

CHECKED BY:

REV. DESCRIPTION