


## MOUSING AUTHORITY OF FRANKFORT, KY

PROJECT KY3-904

## FURNACE REPLACEMENT

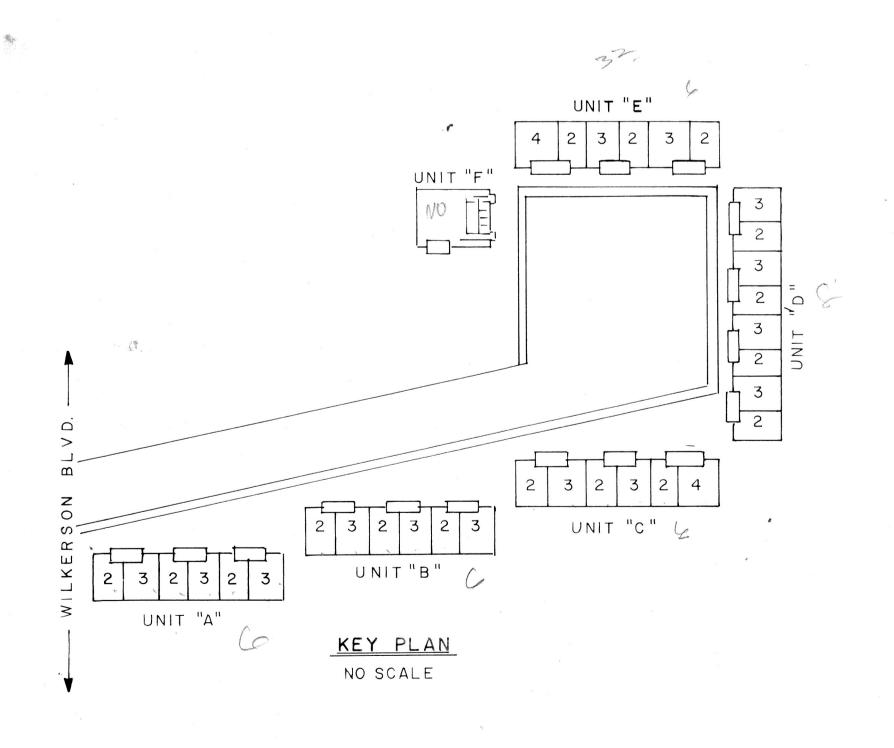


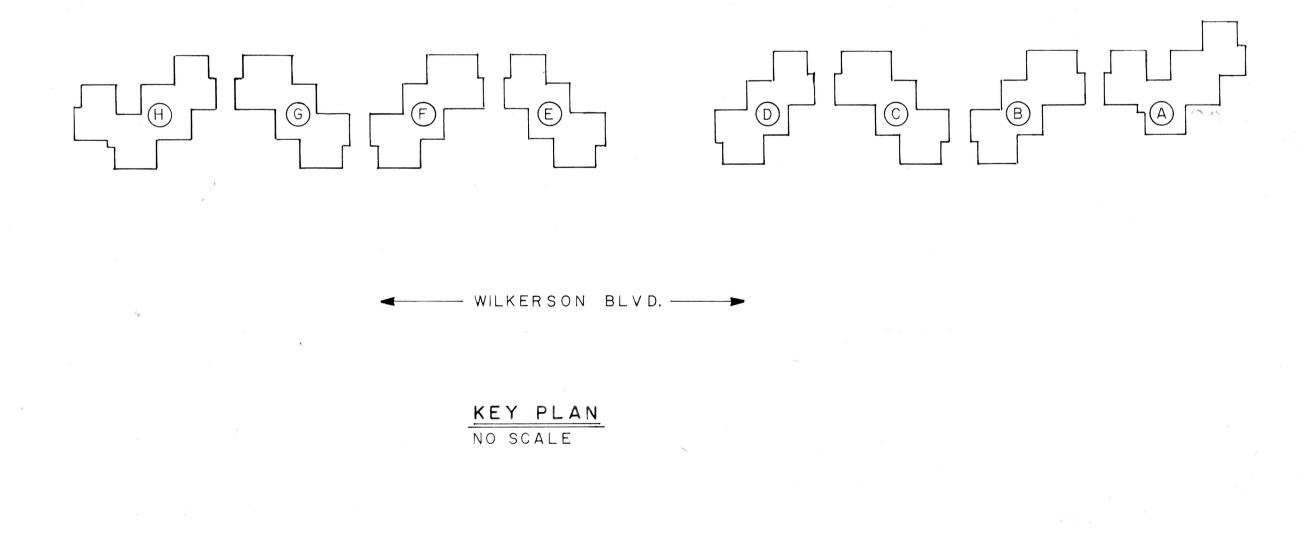

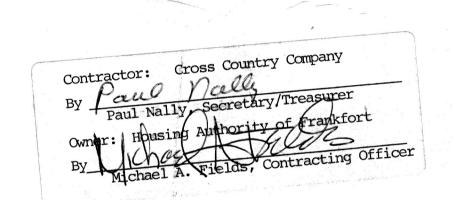

O & W ASSOCIATES, INC.

CONSULTING ENGINEERS
ELIZABETHTOWN, KY

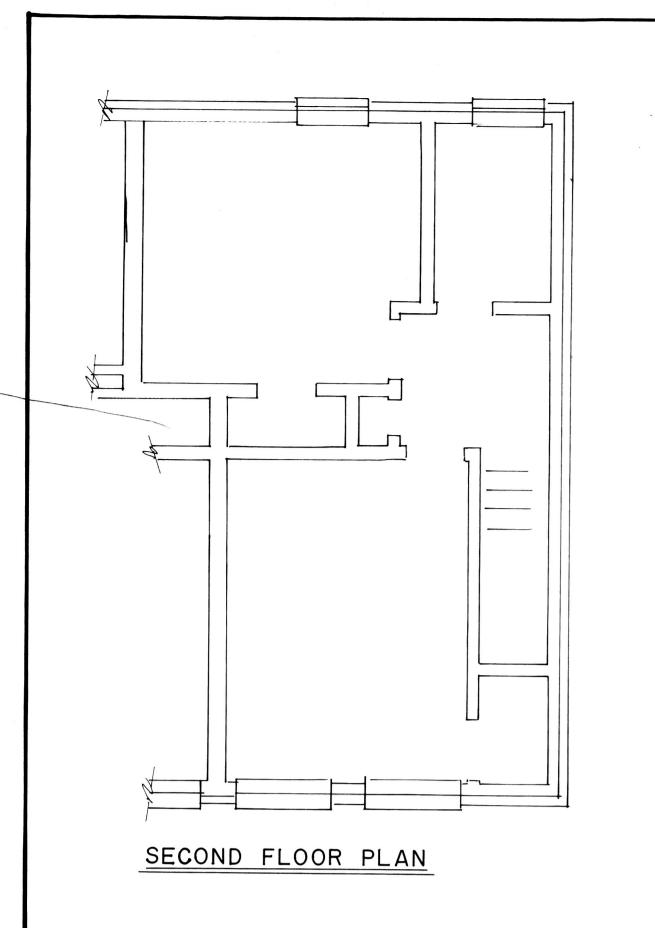



FIRST FLOOR PLAN

SCALE: 1/4"=1'-0"

TYPICAL 2-BEDROOM UNIT

WITH EXTERIOR SIDE WALL

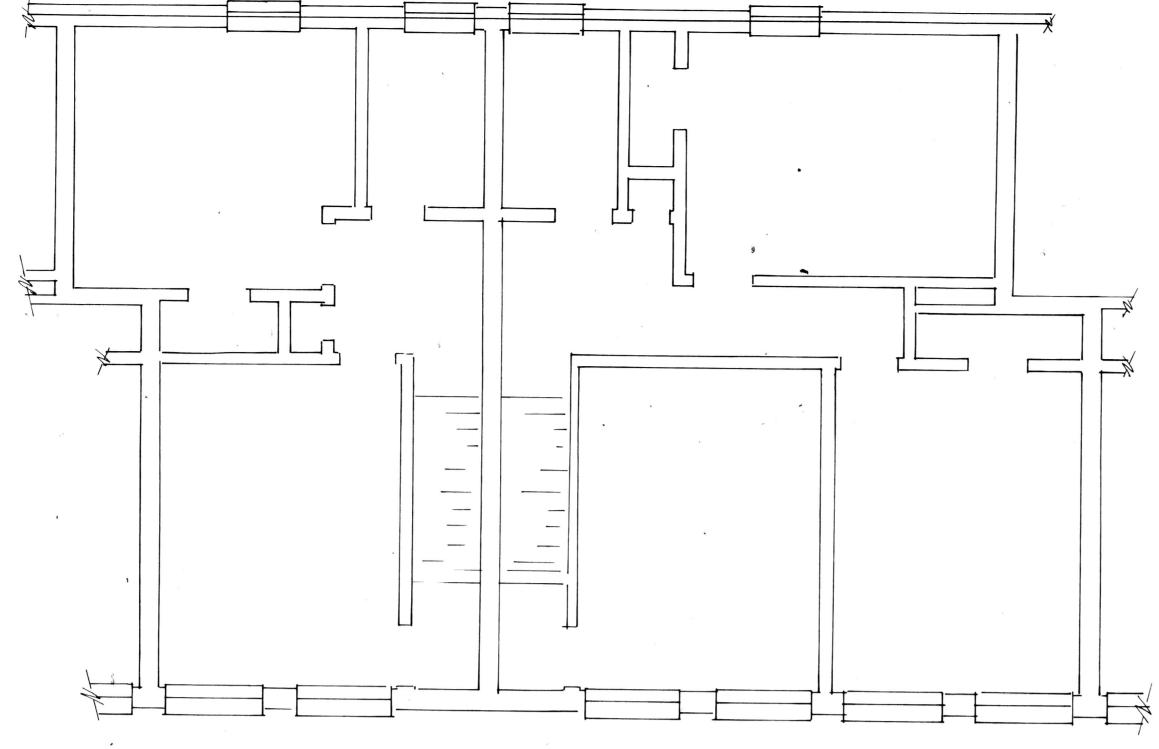

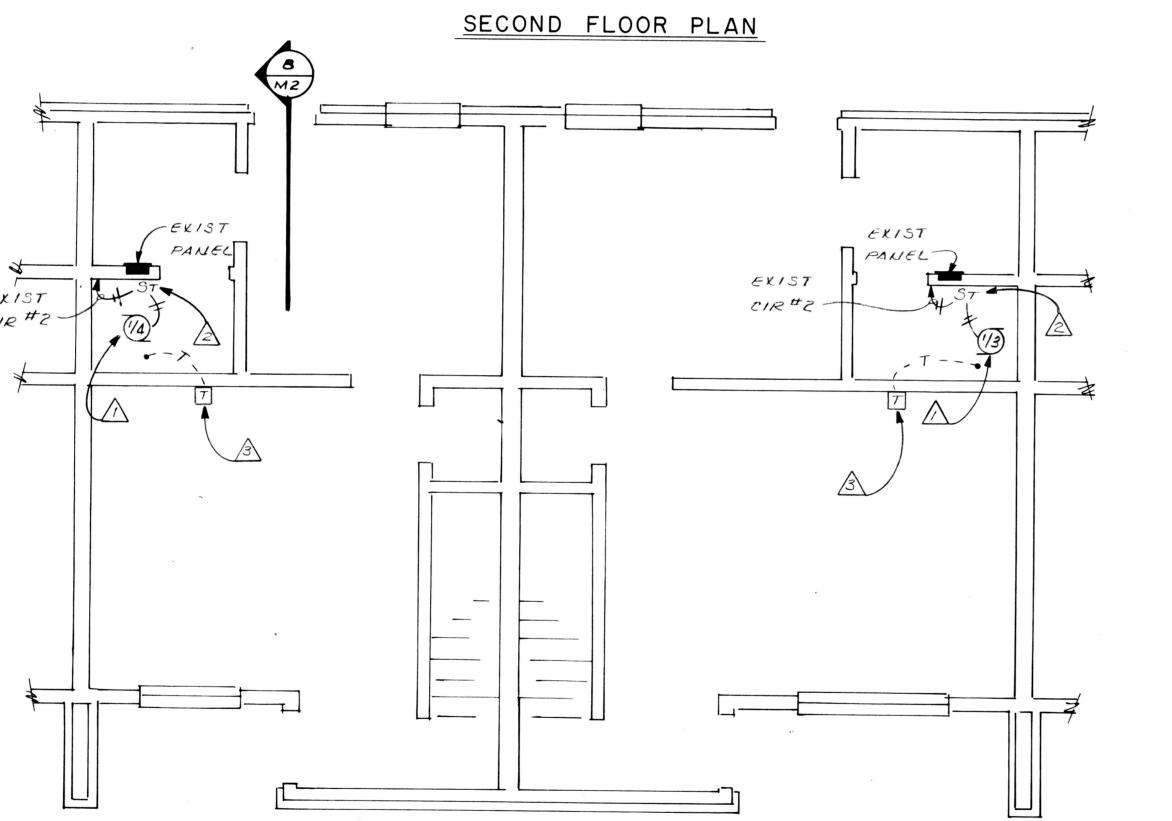



TYPICAL UNIT WITH INTERIOR
SIDE WALL

2-BEDROOM

SCALE: 1/4 "= 1'-0"

3-BEDROOM

EGEND

NEW FURNACE MOTOR 1/2 H.P.


NEW THERMOSTAT (45 DEGREES F TO 75 DEGREES F)

EXIST. FURNACE SWITCH (MANUAL STARTER)


EXIST THERMOSTAT WIRING - LOW VOLTAGE

EXIST. FLEXIBLE CONDUIT OR EMT

DAMPER ACTUATOR (FURNISHED & INSTALLED BY HVAC CONTRACTOR - WIRED BY ELEC. CONTRACTOR)

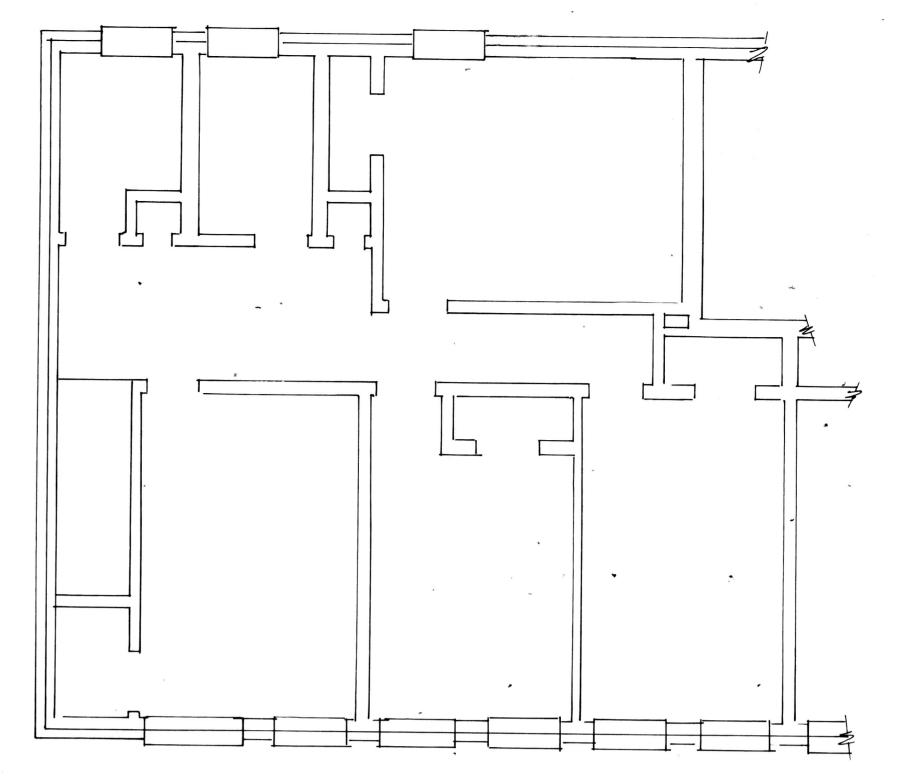

SECOND FLOOR PLAN

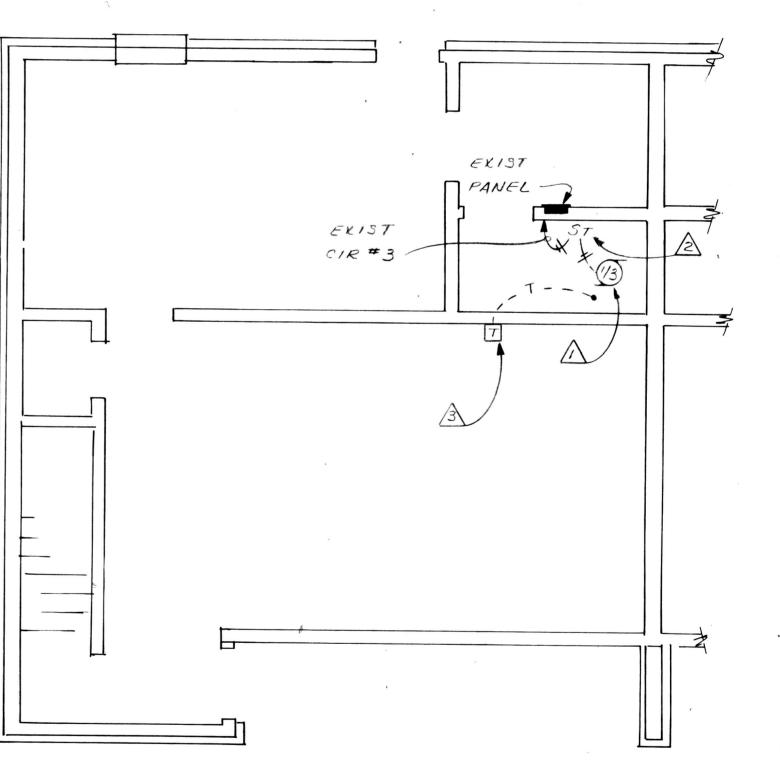


FIRST FLOOR PLAN

## TYPICAL 4-BEDROOM UNIT

SCALE: 1/4"= 1'-0"

NOTES  $\triangle$ 

- 1. DISCONNECT WIRES FROM EXIST. FURNACE AND READY FOR REMOVAL BY MECH. CONTRACTOR. REUSE EXISTING WIRES AND CONNECT TO NEW FURNACE. IN SITUATIONS WHERE EXISTING CONDUIT INTERFERES WITH INSTALLATION OF NEW FURNACE, RELOCATE CONDUIT TO FACILITATE INSTALLATION.
- EXIST. MANUAL STARTER WITH THERMAL OVERLOAD TO BE REUSED. THIS CONTRACTOR
  TO REPLACE THERMAL OVERLOAD OF THE PROPER SIZE BASED ON NEW MOTOR FULL LOAD
  CURRENT RATING.
- 3. REMOVE EXIST. T-STAT. THIS CONTRACTOR TO INSTALL NEW T-STAT, LEVEL AND ADJUST THERMOSTAT HEAT ANTICIPATOR TO THE AMP. SETTING AS RECOMMENDED BY THE NEW FURNACE GAS VALVE MANUFACTURER.
- 4. MOTORIZED DAMPER FURNISHED & INSTALLED BY HVAC CONTRACTOR. ELECTRICAL CONTRACTOR TO WIRE COMPLETE INTERLOCK WITH FURNACE SO THAT MOTORIZED DAMPER OPENS WHEN FURNACE IS ON AND DAMPER CLOSES WHEN FURNACE IS OFF.
- 5. PROVIDE-1/2" EMT WITH 2 #14 & GROUND FROM DAMPER TO AREA NEAR FURNACE USE FLEX. CONDUIT TO MAKE FINAL CONNECTION TO FURNACE.

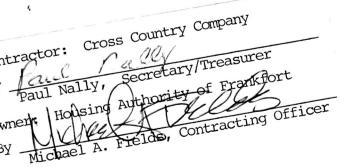

DRAWN BY


CHECKED BY
JSWICET


DRAWING #


E-I


DATE 22DEC87

DRAW
CHEC

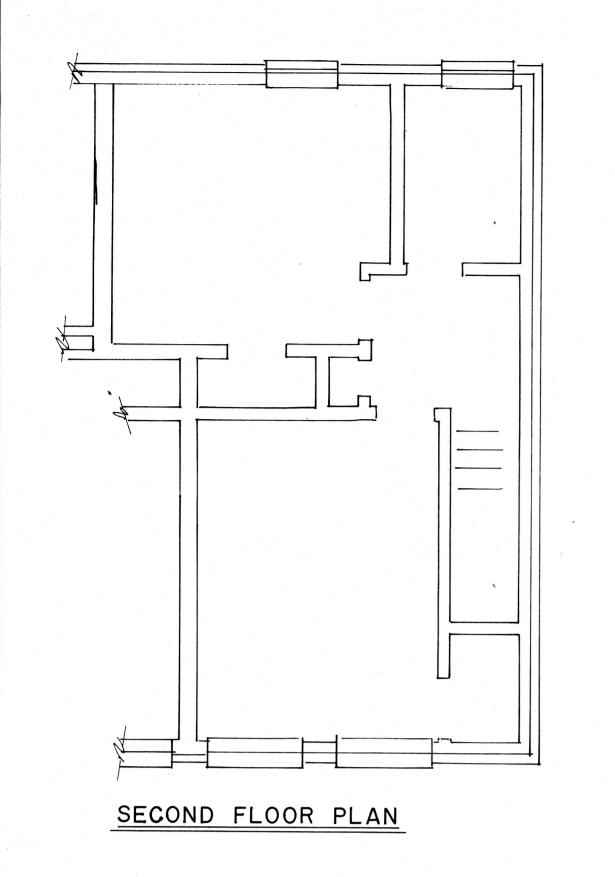

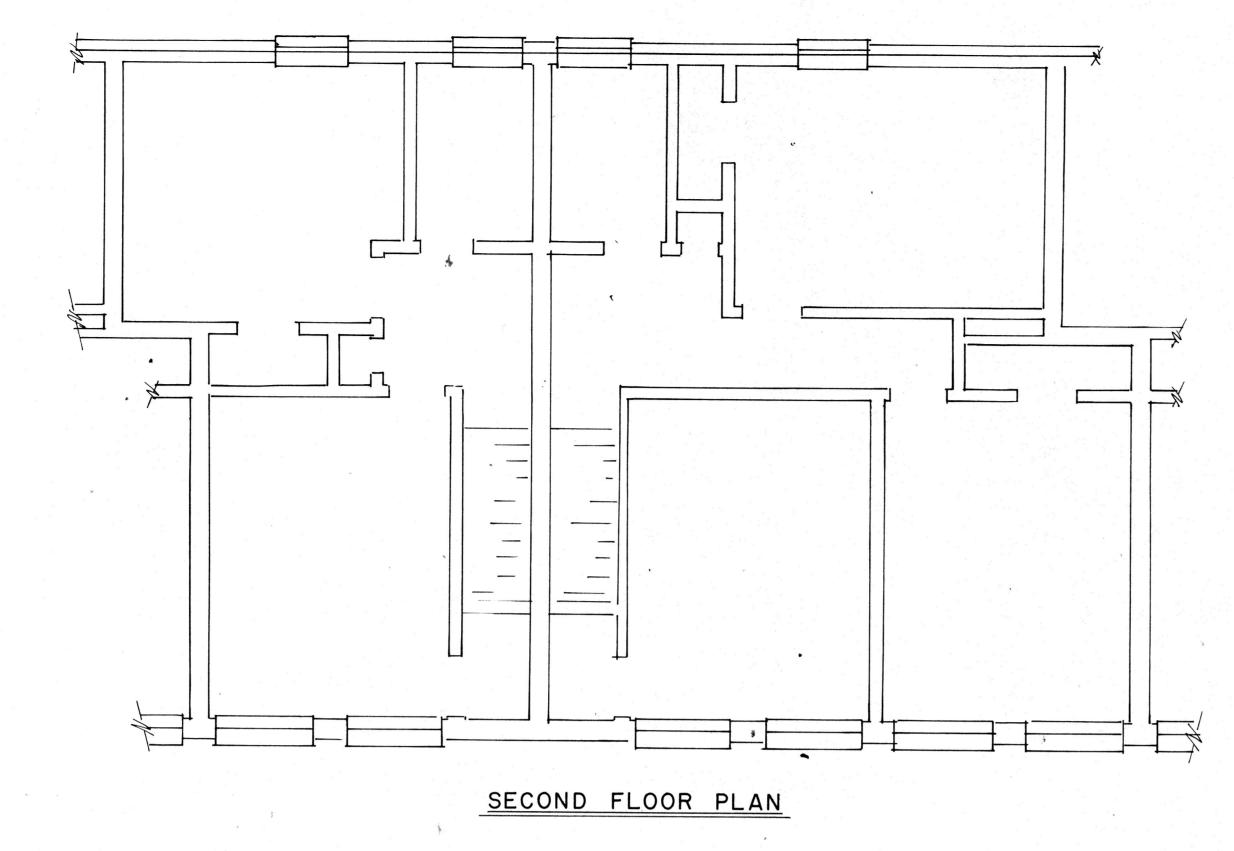

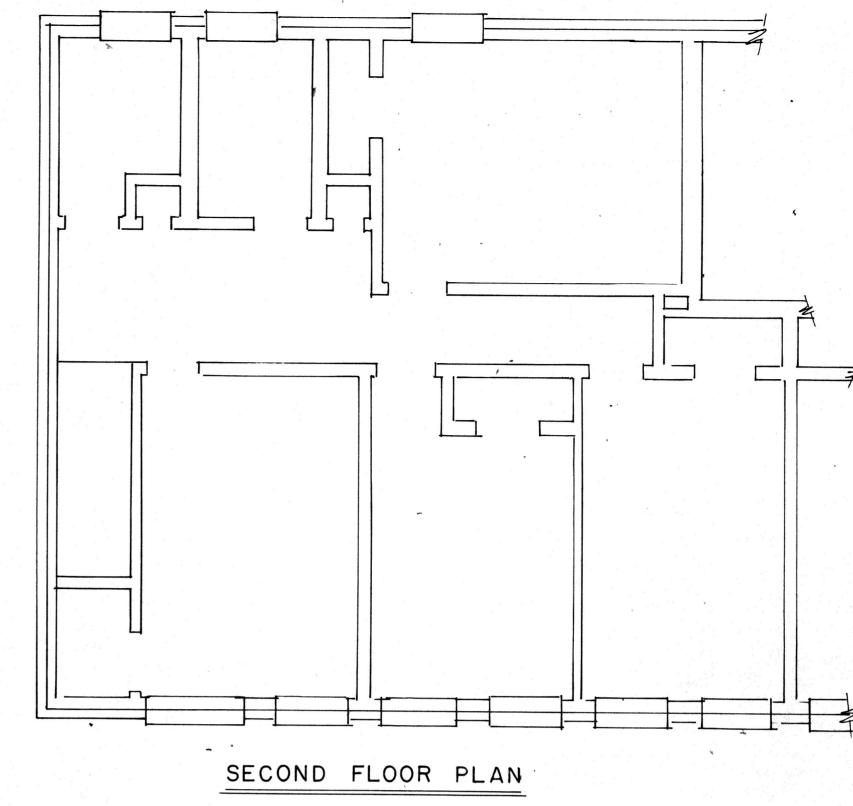

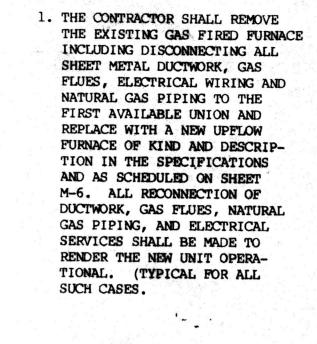

## NOTE 2:

NOTE 1:

 ALL EXISTING AND NEW VENTS SHALL BE EXTENDED AND FLASHED THROUGH NEW ROOF AND COORDINATED WITH ROOFING CONTRACTOR.


LSN GF-1

FIRST FLOOR PLAN

TYPICAL 2-BEDROOM UNIT
WITH EXTERIOR SIDE WALL

SCALE; 1/4"=1"-0"

THIS PLAN TYPICAL OF 5 UNITS TOTAL

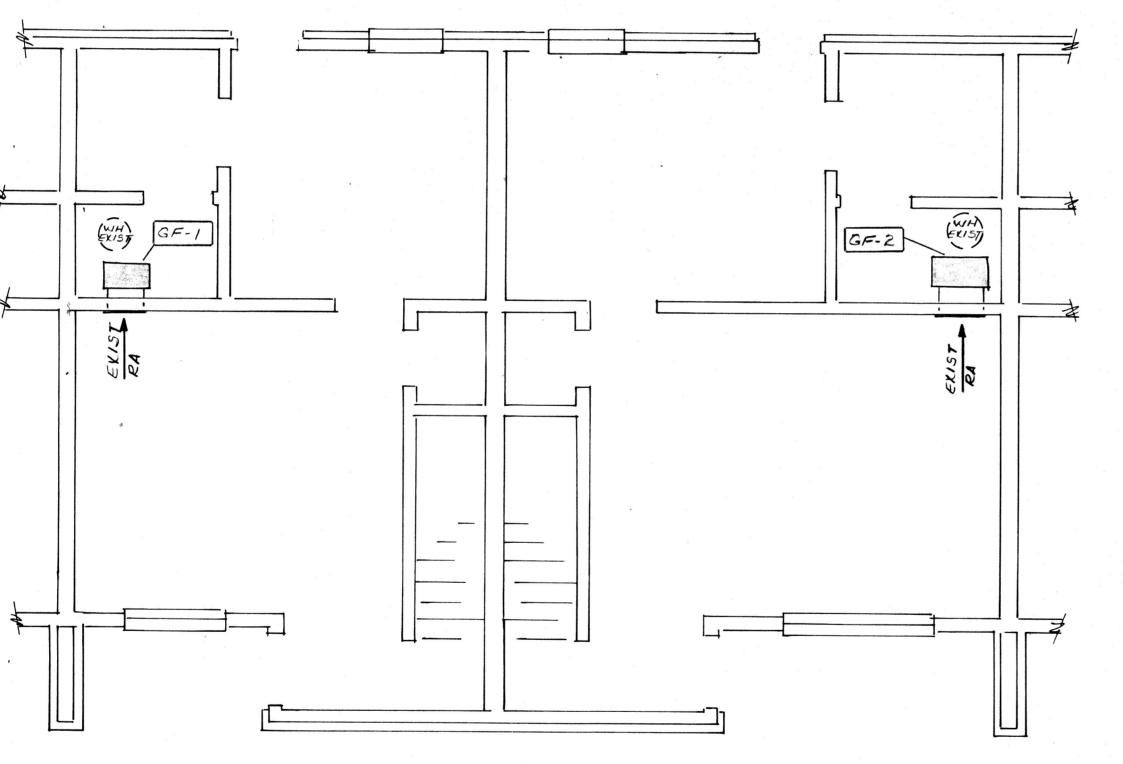

FIRST FLOOR PLAN


TYPICAL UNIT WITH INTERIOR

SIDE WALL

2-BEDROOM
THIS PLAN TYPICAL OF

SCALE: 1/4 "= 1'-0"

3-BEDROOM
THIS PLAN TYPICAL
OF ILUNITS TOTAL

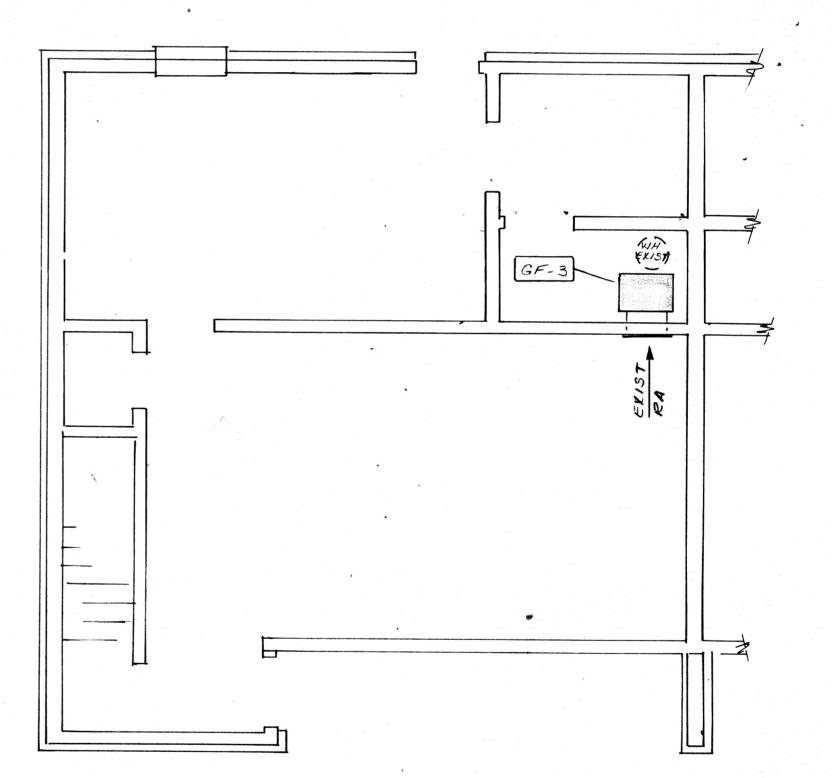

FIRST FLOOR PLAN

TYPICAL 4-BEDROOM UNIT

SCALE: 1/4"= 1'-0"

THIS PLAN TYPICAL OF 2 UNITS TOTAL







CHECKED BY JSW/GDB DRAWING #

M-I

DATE 22DEC87 JOB #

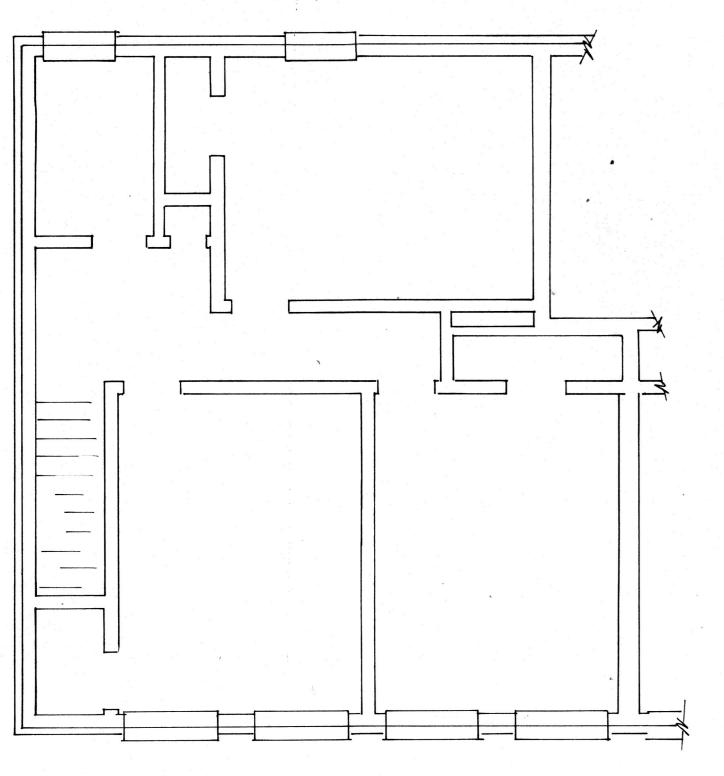


SECOND FLOOR PLAN

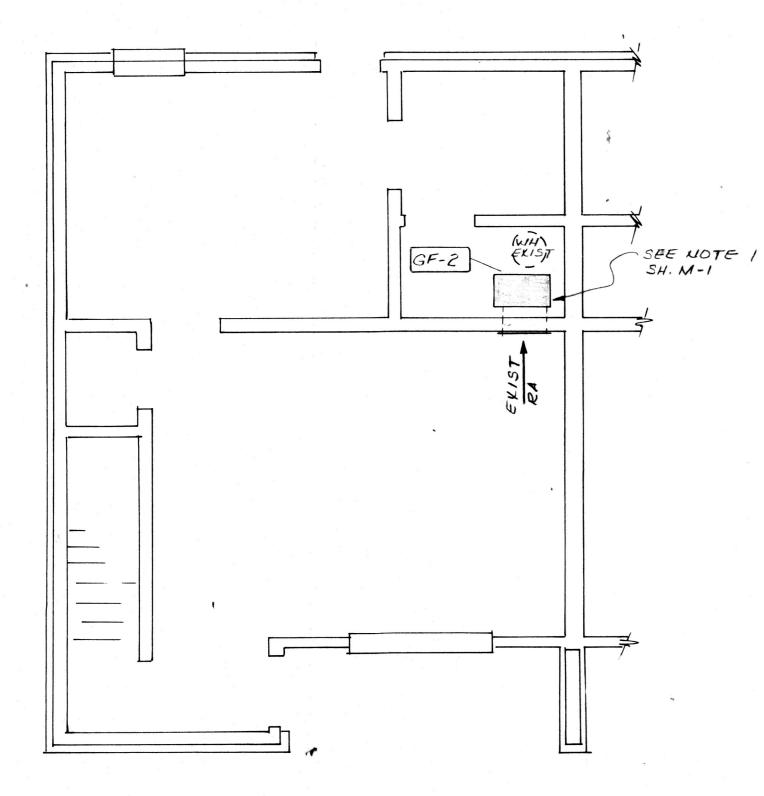


FIRST FLOOR PLAN


SCALE: 1/4 "= 1' - 0"

TYPICAL 3-BEDROOM UNIT
WITH EXTERIOR SIDE WALL
THIS PLAN TYPICAL OF 3 UNITS TOTAL

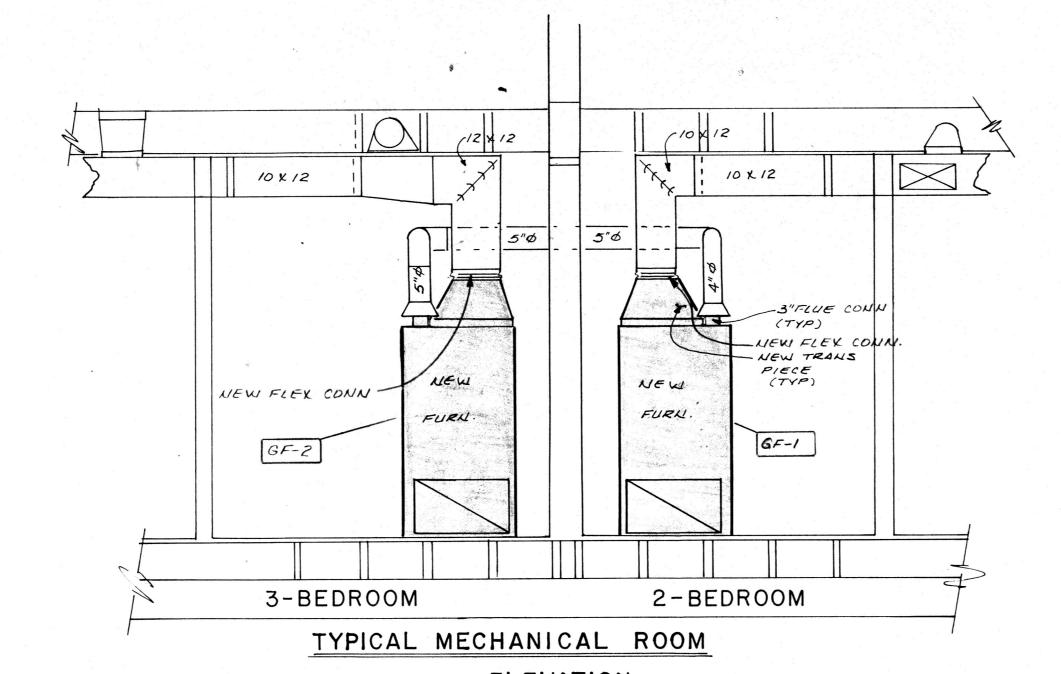

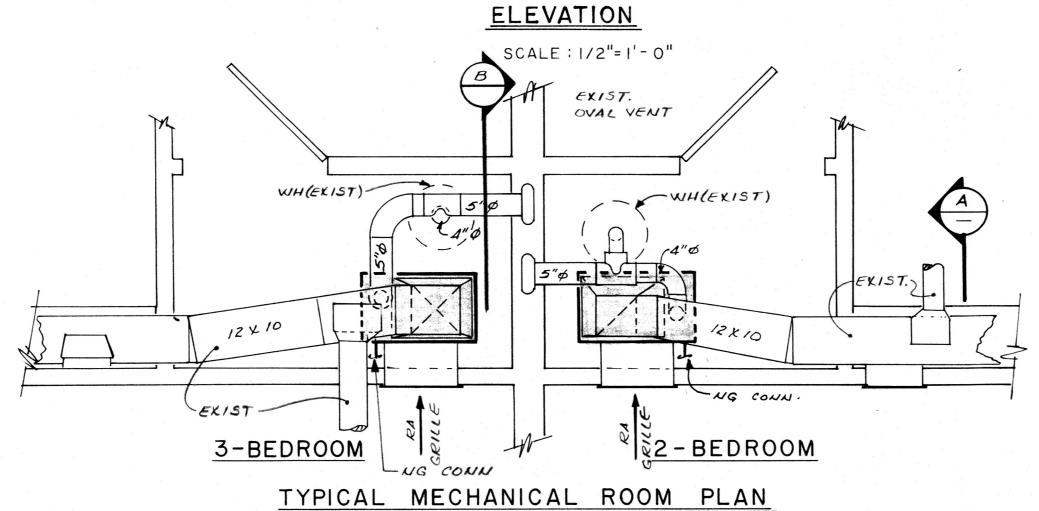


SCALE: 1/2"= 1'- 0"

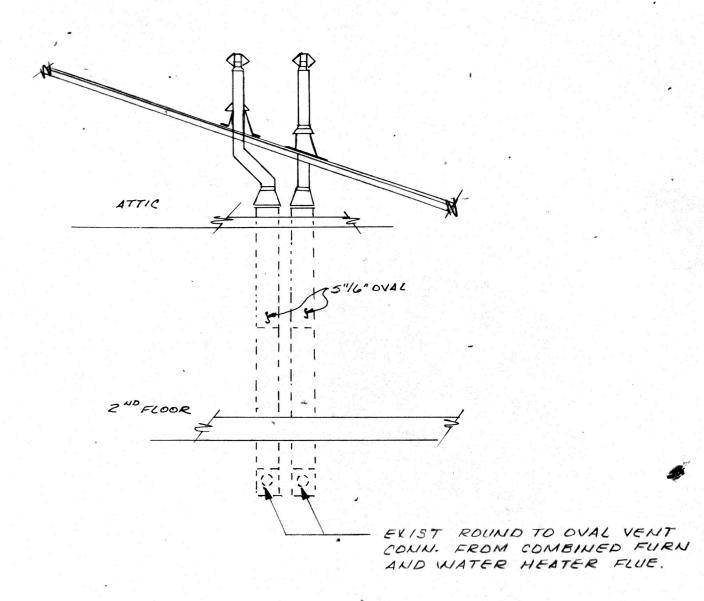

EKISTING VENT FLUE DETAIL
FOR NEW FURNACE AND EXIST.
WATER HEATER

SCALE: 1/4 "= |-0"

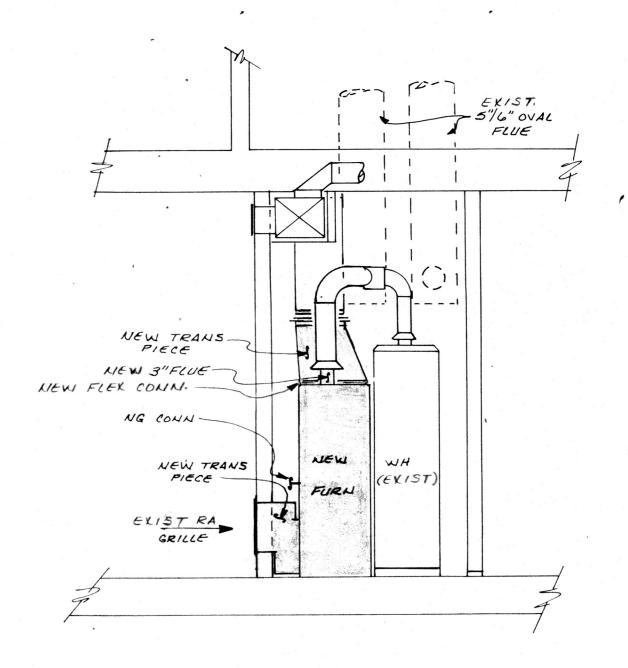

SECTION A

NOTE 1:

1. THE CONTRACTOR SHALL REMOVE
THE EXISTING GAS FIRED FURNACE
INCLUDING DISCONNECTING ALL
SHEET METAL DUCTWORK, GAS
FLUES, ELECTRICAL WIRING AND
NATURAL GAS PIPING TO THE
FIRST AVAILABLE UNION AND
REPLACE WITH A NEW UPFLOW
FURNACE OF KIND AND DESCRIPTION IN THE SPECIFICATIONS
AND AS SCHEDULED ON SHEET
M-6. ALL RECONNECTION OF
DUCTWORK, GAS FLUES, NATURAL
GAS PIPING, AND ELECTRICAL
SERVICES SHALL BE MADE TO
RENDER THE NEW UNIT OPERATIONAL. (TYPICAL FOR ALL
SUCH CASES.

NOTE' 2:

1. ALL EXISTING AND NEW VENTS SHALL BE EXTENDED AND FLASHED THROUGH NEW ROOF AND COORDINATED WITH ROOFING CONTRACTOR.

OF KENNING WATSON
13,036

M-2
DATE
22DEC 87

JOB #

DRAWN BY

CHECKED BY

DRAWING #